

KENYA RURAL ROADS AUTHORITY

DESIGN AND CONSTRUCTION SUPERVISION WORKS FOR IMPLEMENTATION OF GOK/EU/AFD ROADS 2000 CLIMATE PROOFED RURAL ROADS IN ARID AND SEMI-ARID LANDS (ASAL) PROGRAMME

AREA 2-BATCH 1: ISIOLO COUNTY

REHABILITATION, IMPROVEMENT, AND ROUTINE MAINTENANCE WORK: ISIOLO-MLANGO-OLDONYIR (C342) (10.0KM)

FINAL DETAILED ENGINEERING DESIGN BOOK OF DRAWINGS

AUGUST 2023

EMPLOYER:



DIRECTOR (PLANNING, DESIGN AND ENVIRONMENT KENYA RURAL ROADS AUTHORITY (KeRRA) P.O. BOX 48151 – 00100, NAIROBI

CONSULTANT:



CAS CONSULTANTS LTD
LE'MAC BUILDING,1ST FLOOR, OFF
CHURCH ROAD, WESTLANDS,
NAIROBI, KENYA
P.O BOX 20023-0200
TEL: +254(020)4445265, +254722829554

EMAIL: info@casconsultants.co.ke

ISIOLO-MLANGO-OLDONYIRO (C342 02B)			
GRAVEL ROADS BOOK OF DRAWING			
DRAWING No. GENERAL DRAWINGS			
R2000/IMO/2023/GEN/01.	DRAWING INDEX		
R2000/IMO/2023/GEN/02.	PROJECT LOCATION MAP		
TYPICAL CI	ROSS-SECTIONS		
R2000/IMO/2023/TCS/01	CROSS-SECTION A(STANDARD CROSS-SECTION)		
R2000/IMO/2023/TCS/02	CROSS-SECTION B (REDUCED CROSS-SECTION)		
R2000/IMO/2023/TCS/03	CROSS-SECTION C (BLACK COTTON SOIL CROSS-SECTION)		
R2000/IMO/2023/TCS/04	CROSS-SECTION D (SIDELONG GROUND CROSS-SECTION)		
R2000/IMO/2023/TCS/05	DETAILED TYPICAL CROSS-SECTION AND BENCHING DETAILS		
	PIPE CULVERTS		
R2000/IMO/2023/PC/01	HEAD WALL TYPE 1		
R2000/IMO/2023/PC/02	HEAD WALL TYPE 2		
R2000/IMO/2023/PC/03	HEAD WALL TYPE 3		
R2000/IMO/2023/PC/04	HEAD WALL TYPE 4		
R2000/IMO/2023/PC/05	PIPE CULVERT DETAILS		
R2000/IMO/2023/PC/06	BEDDING AND HAUNCH		
	MAJOR DRAINANGE STRUCTURES		
R2000/IMO/2023/DRT/01	30M LONG DRIFTS		
	STANDARD DRAWINGS		
R2000/IMO/2023/SD/01	STANDARD JUNCTION AND ACCESS DETAILS		
R2000/IMO/2023/SD/02	STANDARD BUSBAY AND KERB DETAILS		
R2000/IMO/2023/SD/03	STANDARD MARKER POST DETAILS		
R2000/IMO/2023/SD/04	STANDARD GUARD RAIL DETAILS		
	GENERAL DRAINAGE		
R2000/IMO/2023/GDR/01	MITRE DRAIN DETAILS		
R2000/IMO/2023/GDR/02	SCOUR CHECKS		
R2000/IMO/2023/GDR/03	SCOUR CHECKS		
R2000/IMO/2023/GDR/04	SCOUR CHECKS		
R2000/IMO/2023/GDR/05	ACCESS DRIFTS		
	TRAFFIC SIGNS		
R2000/IMO/2023/TS/01	STANDARD TRAFFIC SIGNS		
	PUBLICITY SIGNBOARD		
R2000/IMO/2023/PSB/01	PUBLICITY SIGNBOARD DETAILS		

Client:	Approved By:	Date:	NO Revisions:
			1.
			2.
-			
KEN			











CAS CONSULTANTS LTD
Le'Mac Building, 1st Floor, off Church
Road, Westlands, Nairobi, Kenya
P.O.Box 20023,00200
Tel+254 (020) 4445265, +254722829554
Email: info@casconsultants.co.ke

Project:

DESIGN AND SUPERVISION WORKS FOR IMPLEMENTATION OF THE CLIMATE PROOFED RURAL ROADS IN ARID AND SEMI-ARID LANDS (ASAL) - AREA 2.

I	Drawing title:			Drawn by	: R.T
ODAN/EL DOADO				Designed by	: N.O
	GRAVEL ROADS			Checked by	: C.O
				Approved by	: C.O
ı				Date	: AUGUST, 2023.
I	Scale: (AS SHOWN)	Sheet:		Client approval	:
1			1 of 1		

LOCATION MAP















CAS CONSULTANTS LTD
Le'Mac Building, 1st Floor, off Church
Road, Westlands, Nairobi, Kenya
P.O.Box 20023,00200
Tel+254 (020) 4445265, +2547228295!
Fmail: info@casconsultants co.ke

Project:

DESIGN AND SUPERVISION WORKS FOR IMPLEMENTATION OF THE CLIMATE PROOFED RURAL ROADS IN ARID AND SEMI-ARID LANDS (ASAL) - AREA 2.

rawing title:				Drawn by	: R.T
OCATION MAP				Designed by	: N.O
				Checked by	: C.O
				Approved by	: C.O
				Date	: AUGUST, 2023.
ale:	(AS SHOWN)	Sheet:		Client approval	:
			1 of 1		

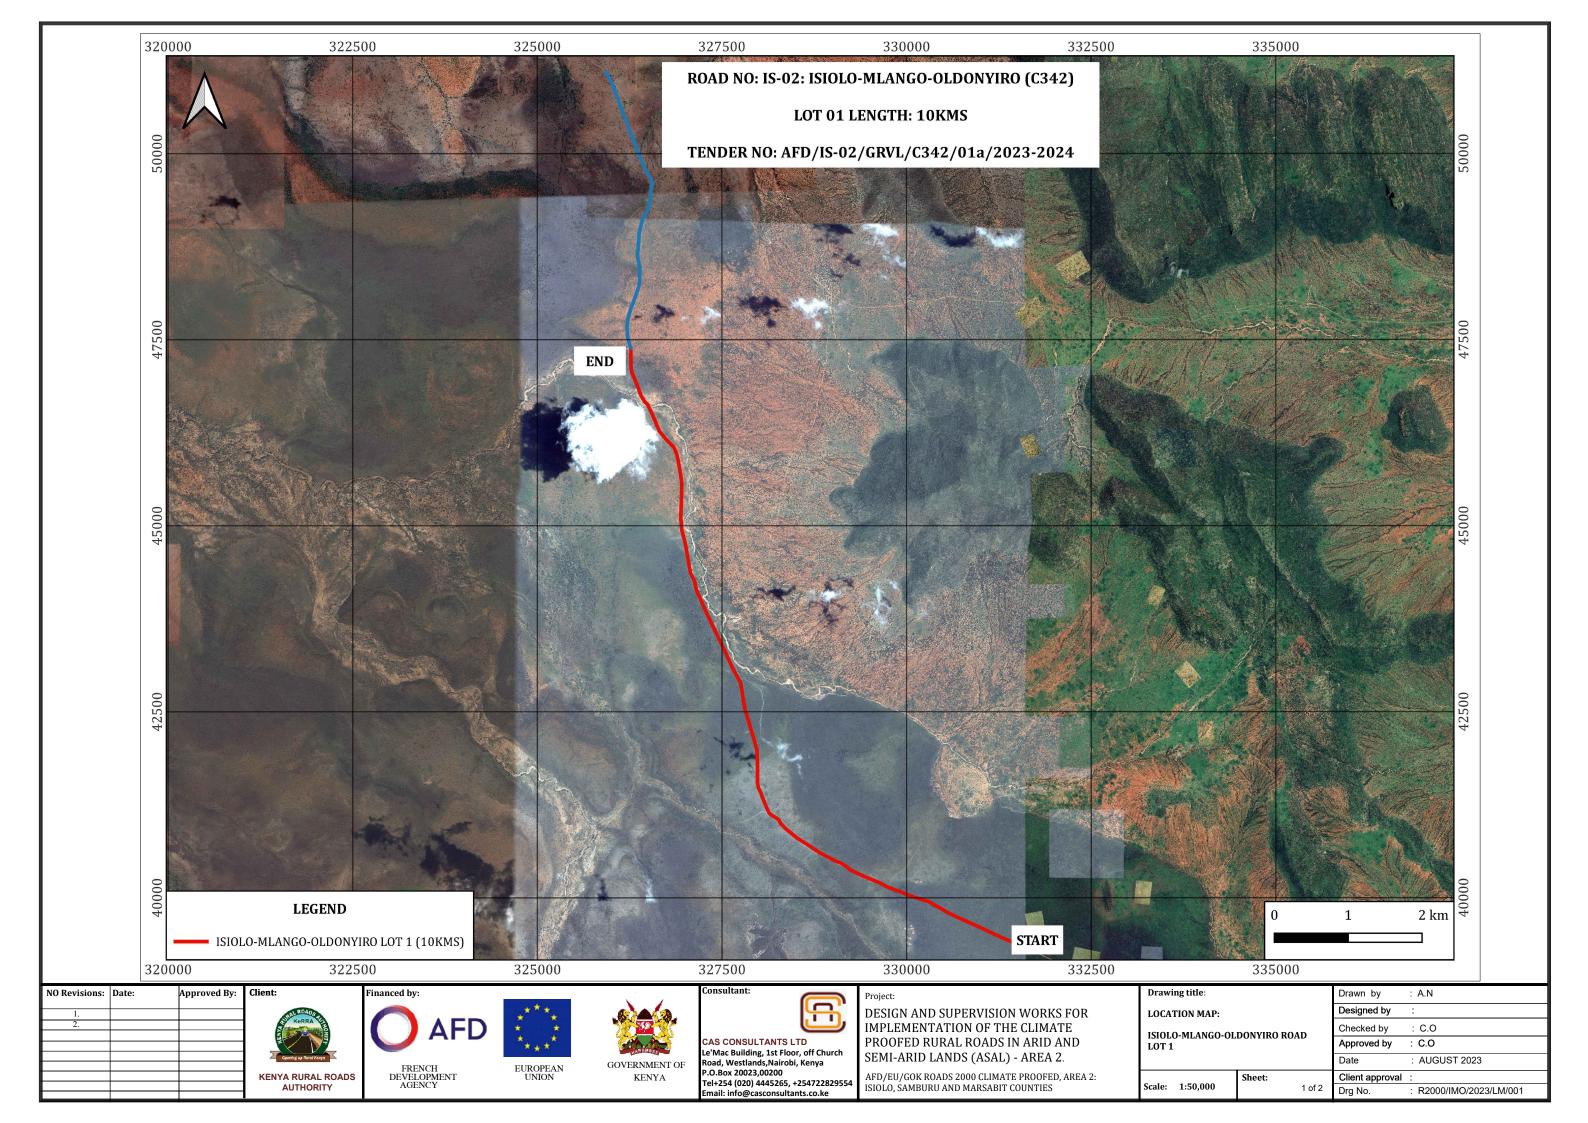

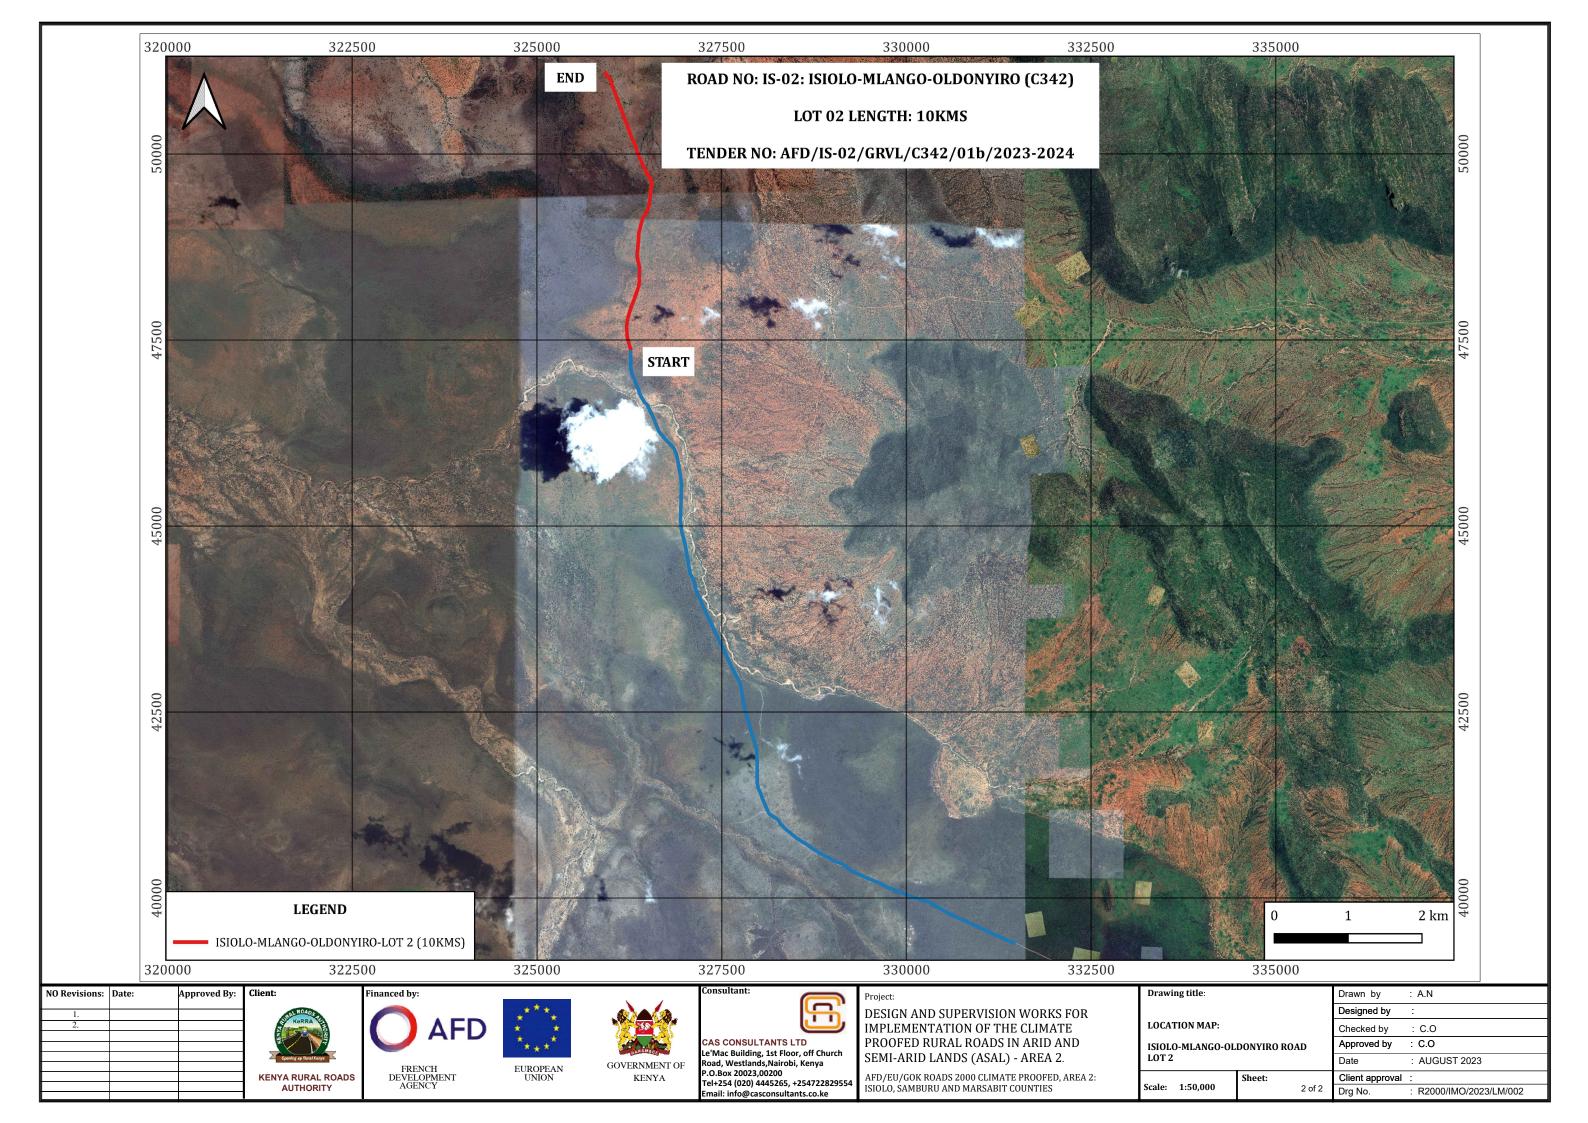

TYPICAL CROSS-SECTIONS













CAS CONSULTANTS LTD Le'Mac Building, 1st Floor, off Church Road, Westlands, Nairobi, Kenya P.O.Box 20023,00200 Tel+254 (020) 4445265, +254722829554

Project:

DESIGN AND SUPERVISION WORKS FOR IMPLEMENTATION OF THE CLIMATE PROOFED RURAL ROADS IN ARID AND SEMI-ARID LANDS (ASAL) - AREA 2.

AFD/EU/GOK ROADS 2000 CLIMATE PROOFED, AREA 2: ISIOLO, SAMBURU AND MARSABIT COUNTIES


rawing	title:	

TYPICAL CROSS-SECTIONS

Scale: (AS SHOWN) Sheet:

	Drawn by	: R.T
	Designed by	: N.O
	Checked by	: C.O
	Approved by	: C.O
	Date	: AUGUST, 2023.
	Client approval	:
1 of 1		

FIGURE H.1 - CROSS SECTION A (MINOR STANDARD CROSS-SECTION)

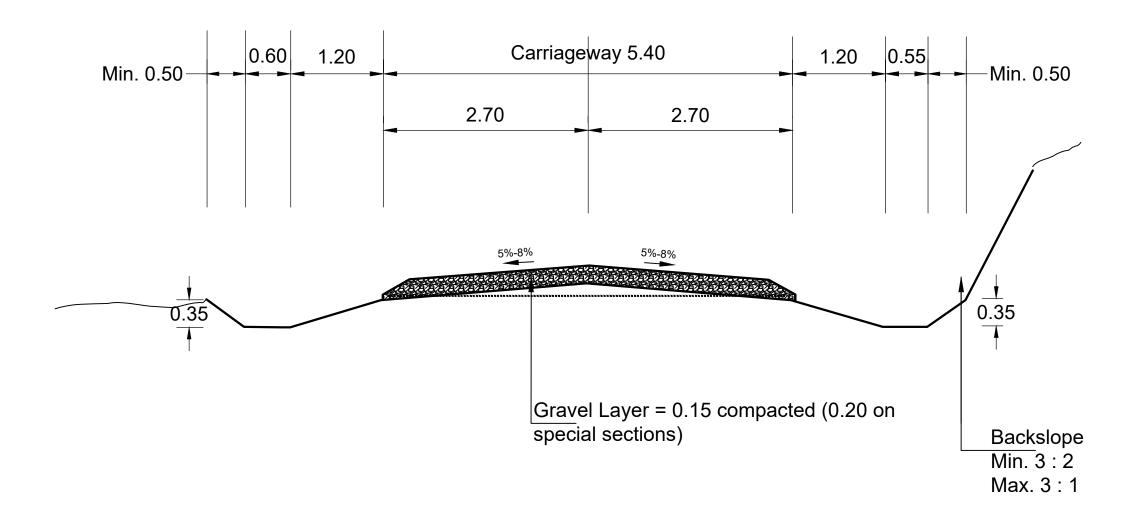


NOTE:

- ALL SPECIFIED DIMENSIONS IN m.
- TRAFFIC LEVELS OF MORE THAN 200 VPD MAY JUSTIFY RUNNING SURFACE WIDTH INCREASE TO 6.50 METRES

NO Revisions:	Date: Approved By:	Client:	Financed by:			Consultant:	Project:	Drawing title:	Drawn by :	R.T
1.		ON ROADS		****		الظر"	DESIGN AND SUPERVISION WORKS FOR	CROSS SECTION DRAWINGS	Designed by :	N.O
2.			() AFD	* *			IMPLEMENTATION OF THE CLIMATE		Checked by :	C.O
				****		Lainda a Duildina dat Flagu aff Chuuch	PROOFED RURAL ROADS IN ARID AND	STANDARD CROSS-SECTION DETAILS	Approved by :	C.O
		Opening up Burof Heaps	FRENCH			Le'Mac Building, 1st Floor, off Church Road, Westlands,Nairobi, Kenya	SEMI-ARID LANDS (ASAL) - AREA 2.	DE MILES	Date :	AUGUST, 2023.
		KENYA RURAL ROADS	DEVELOPMENT	UNION	KENYA	P.O.Box 20023,00200 Tel+254 (020) 4445265, +254722829554			Client approval :	
		AUTHORITY	AGENCY			Email: info@casconsultants.co.ke	2: ISIOLO, SAMBURU AND MARSABIT COUNTIES	1 of 1	Drg No. :	R2000/IMO/2023/TCS/01

FIGURE H.2 - CROSS SECTION B (REDUCED CROSS-SECTION)

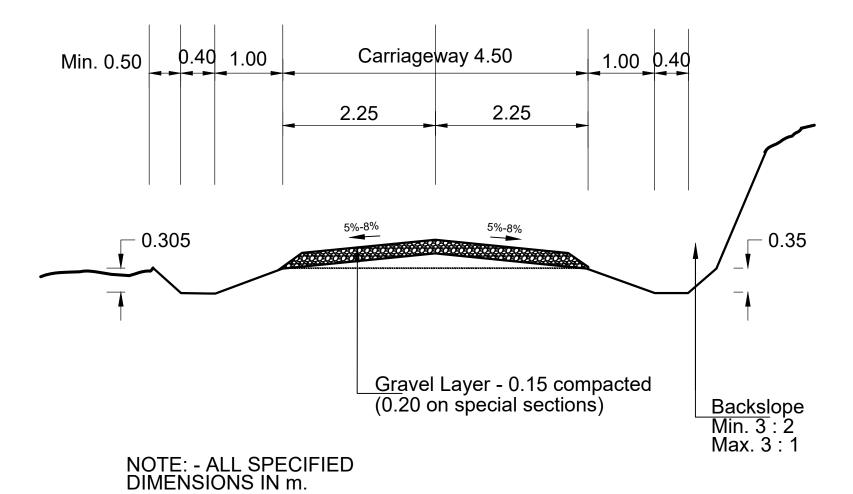











ultant:	D
	<u> </u>
CONSULTAN	NTS LTD at Floor, off Church

Road, Westlands, Nairobi, Kenya P.O.Box 20023,00200 Tel+254 (020) 4445265, +254722829554


Pro	oje	ct	:


DESIGN AND SUPERVISION WORKS FOR IMPLEMENTATION OF THE CLIMATE PROOFED RURAL ROADS IN ARID AND SEMI-ARID LANDS (ASAL) - AREA 2.


AFD/EU/GOK ROADS 2000 CLIMATE PROOFED, AREA
2: ISIOLO, SAMBURU AND MARSABIT COUNTIES

Drawin	g title:		Drawn by	: R.T	
CROSS SECTION DRAWINGS				Designed by	: N.O
				Checked by	: C.O
	REDUCED (ROSS-SECTI	Approved by	: C.O	
	DETAILO		Date	: AUGUST, 2023.	
Scale:	(AS SHOWN)	Sheet:		Client approval	:
			1 of 1	Drg No.	: R2000/IMO/2023/

R2000/IMO/2023/TCS/02

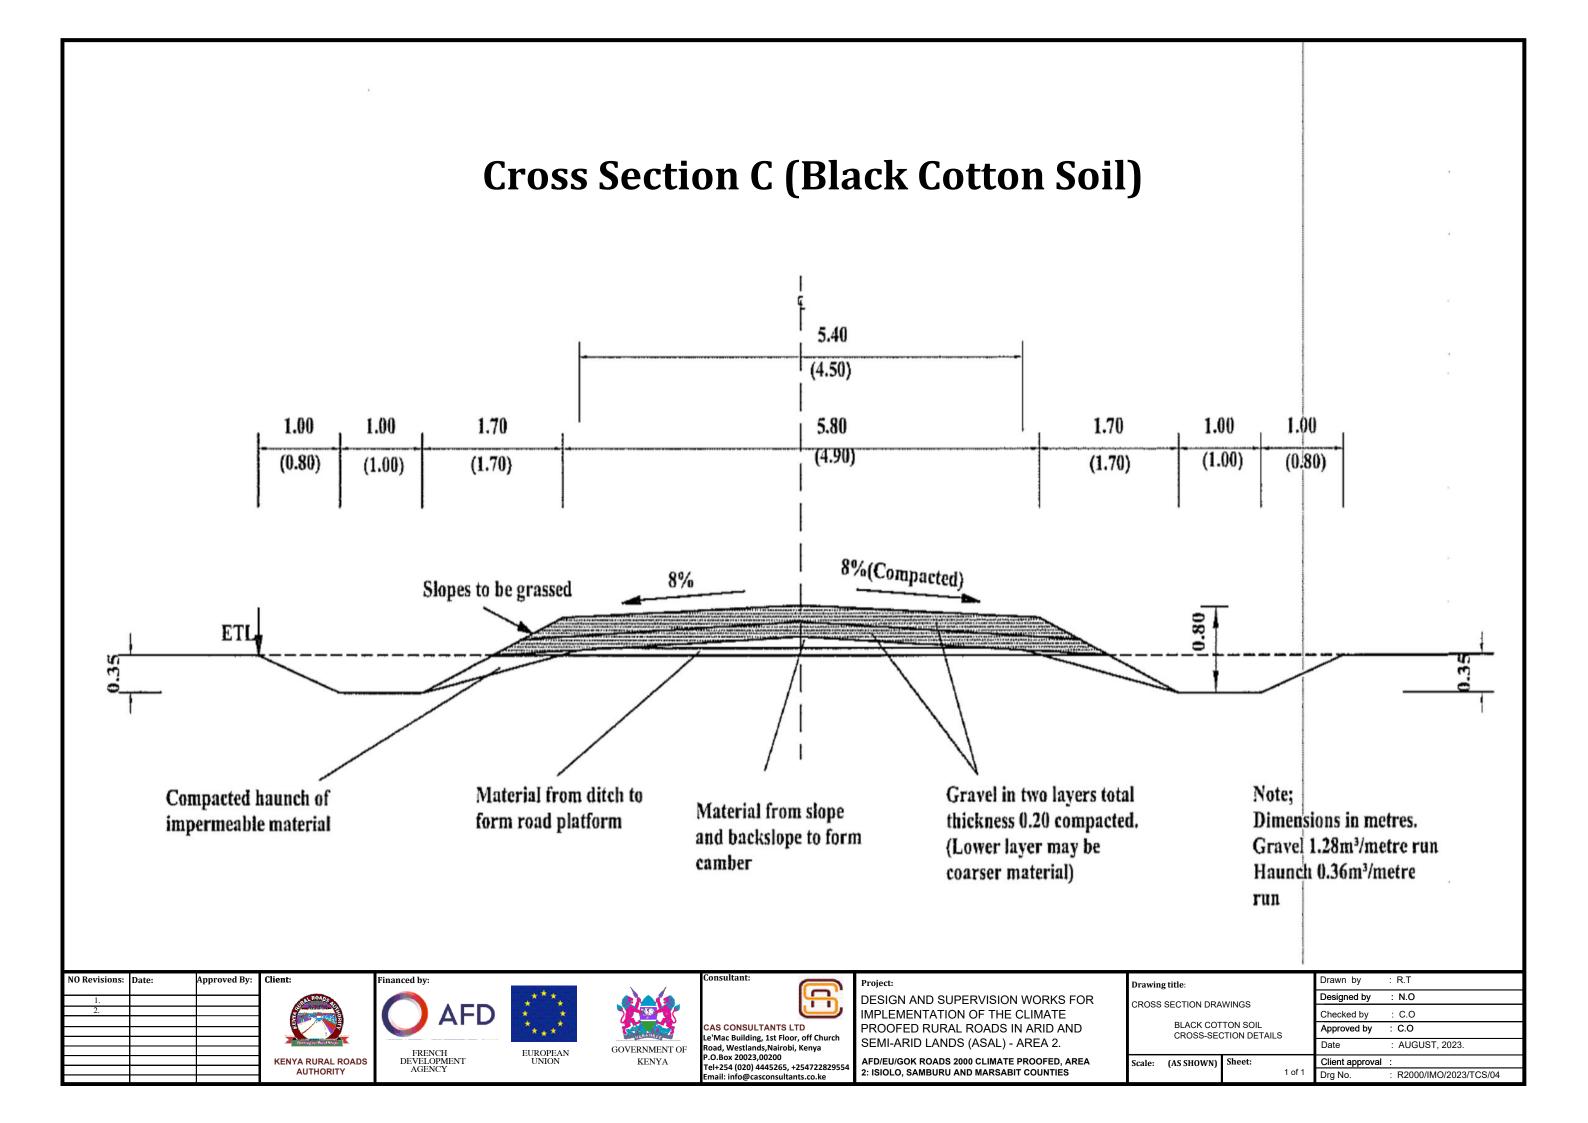

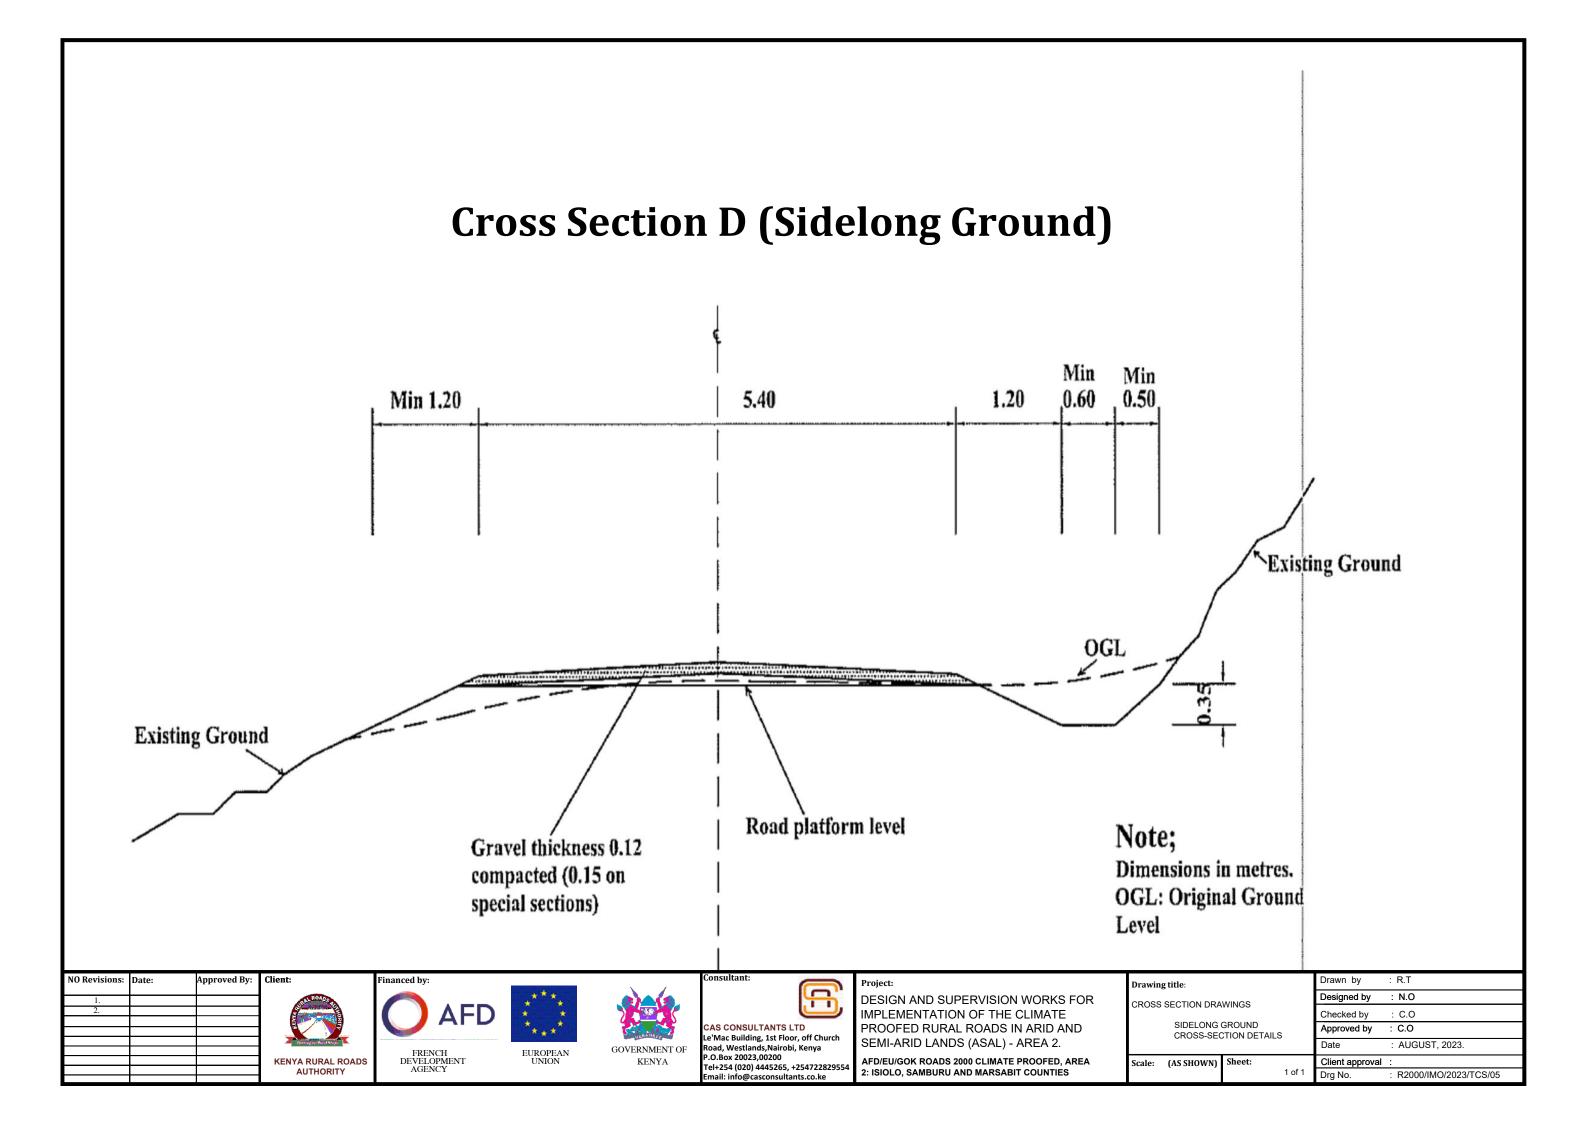

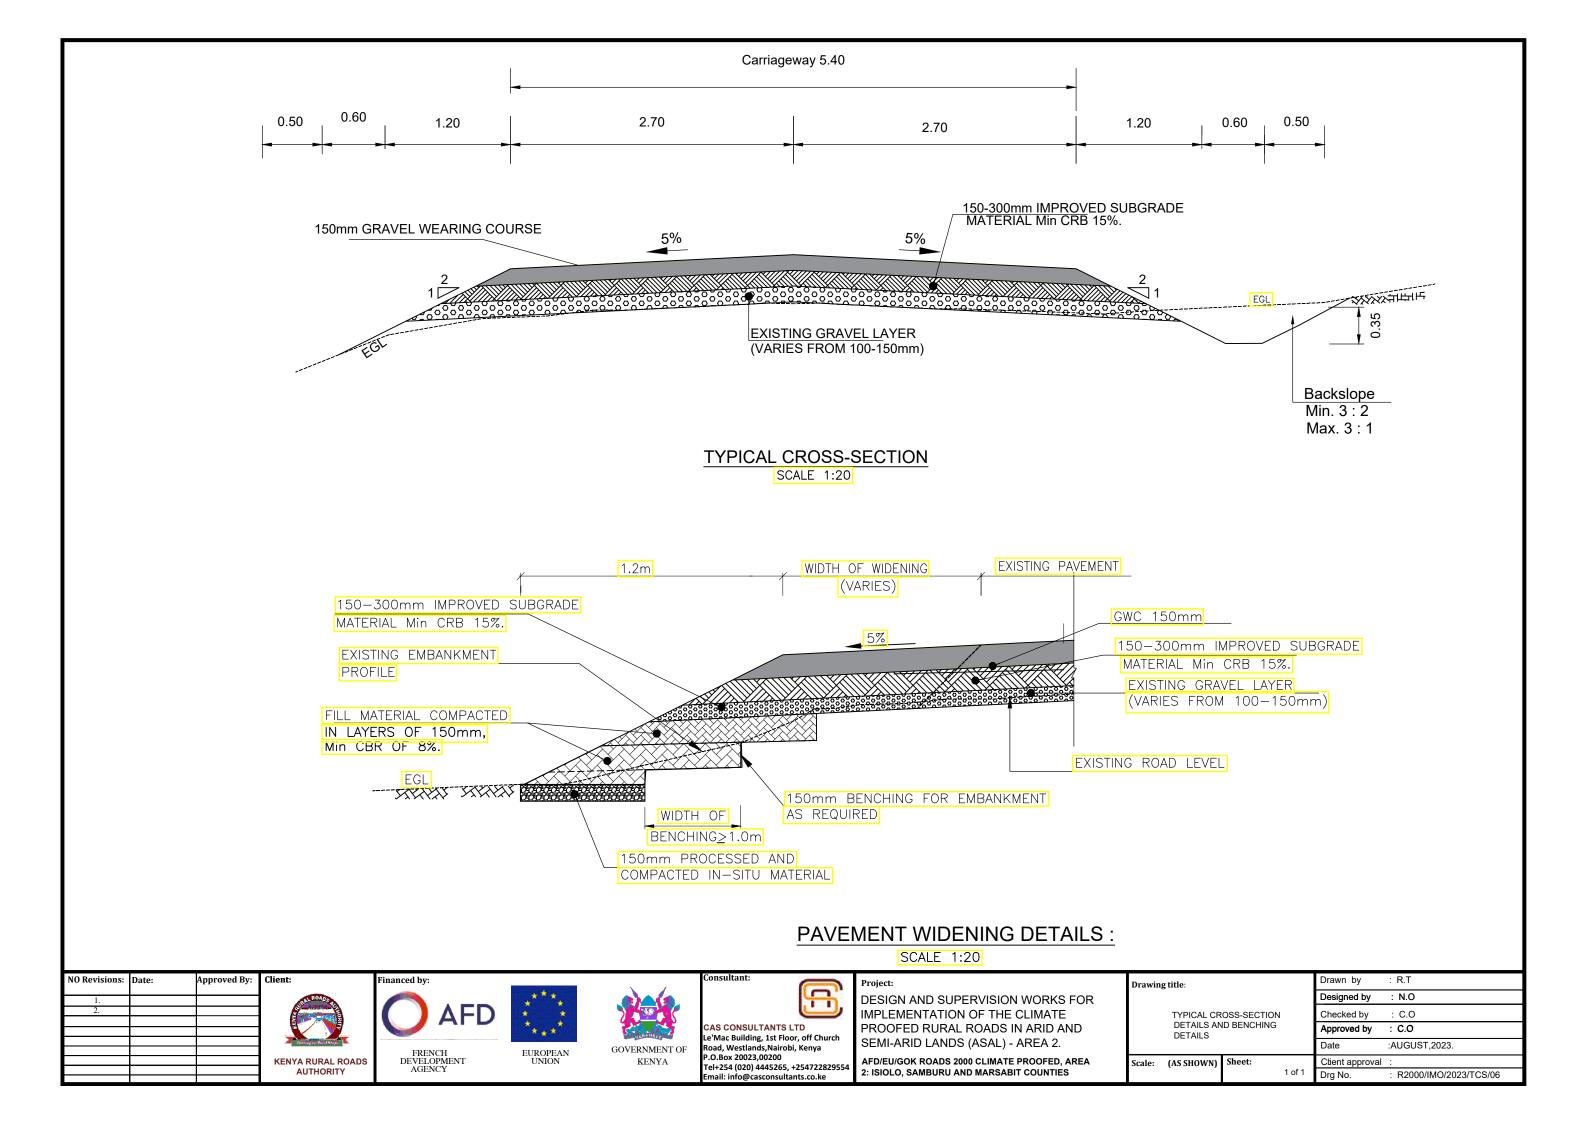

PIPE CULVERTS













CAS CONSULTANTS LTD
Le'Mac Building, 1st Floor, off Church
Road, Westlands, Nairobi, Kenya
P.O.Box 20023,00200
Tel+254 (020) 4445265, +2547228295
Email: info@casconsultants.co.ke

Project:

DESIGN AND SUPERVISION WORKS FOR IMPLEMENTATION OF THE CLIMATE PROOFED RURAL ROADS IN ARID AND SEMI-ARID LANDS (ASAL) - AREA 2.


AFD/EU/GOK ROADS 2000 CLIMATE PROOFED, AREA 2: ISIOLO, SAMBURU AND MARSABIT COUNTIES


PIPE CULVERT DETAILS

Scale: (AS SHOWN) Sheet:

	Drawn by	: R.T
	Designed by	: N.O
	Checked by	: C.O
	Approved by	: C.O
	Date	: AUGUST, 2023.
	Client approval	:
of 7		


C8- HEADWALL TYPE 1 (HEAD AND WINGWALLS

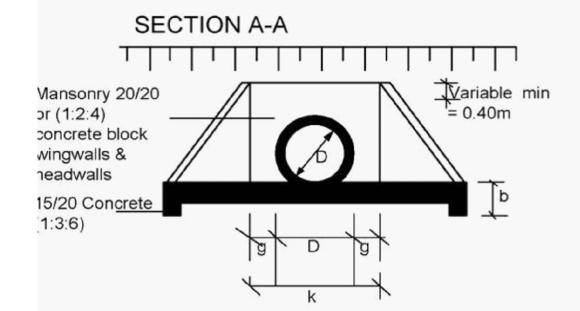

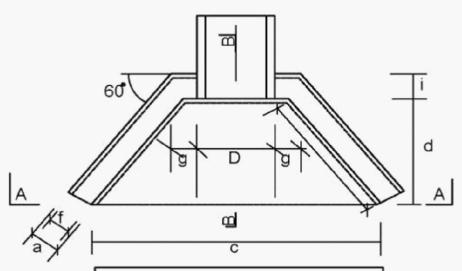

CULVERT TYPES			
X-SECTION WIDTH-M	No. of pipes		
4.50	6.00		
5.50	7.00		
6.50	8.00		



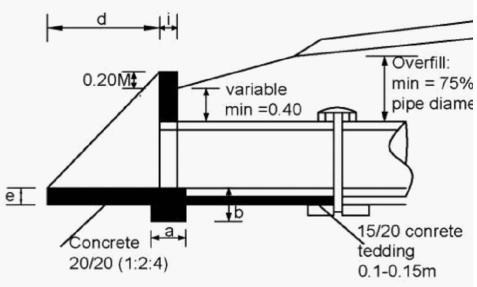

PIPE DIAMETER IN M			TYPE A and C CONCRETE BLOCKS			TYPE B (STONE MASONRY)		
			450	600	900	450	600	900
а	DIMENSION FOUNDATION	UNIT	0.30	0.30	0.30	0.40	0.40	0.60
b	FOUNDATION	m	0.30	0.30	0.40	0.30	0.30	0.40
С	FOUNDATION	m	2.20	2.35	2.89	2.20	2.35	2.89
d	APRON	m	1.00	1.00	1.20	1.00	1.00	1.20
е	APRON	m	0.20	0.20	0.20	0.20	0.20	0.20
f	WALL	m	0.20	0.20	0.20	0.40	0.40	0.40
g	WALL	m	0.30	0.30	0.30	0.30	0.30	0.30
h	WALL	m	1.15	1.15	1.39	1.15	1.15	1.39
İ	WALL	m	0.20	0.20	0.20	0.40	0.40	0.40
k	APRON	m	1.05	1.20	1.50	1.05	1.20	1.50
	MATERIAL REQU	JIREMEN	Т					
FC	UNDATION							
(concrete) m3		0.30	0.32	0.51	0.40	0.42	1.03	
	EAD/WINGWALLS onrete/Masonry) APRON	m3	0.42	0.49	0.70	0.84	0.96	1.40
	(cocrete)	m3	0.33	0.36	0.53	0.33	0.36	0.53

Date:	Approved By:	Clien
		KE
	Date:	Date: Approved By:












CAS CONSULTANTS LTD Le'Mac Building, 1st Floor, off Church Road, Westlands, Nairobi, Kenya P.O.Box 20023,00200 Tel+254 (020) 4445265, +254722829554 Email: info@casconsultants.co.ke


Project:


DESIGN AND SUPERVISION WORKS FOR IMPLEMENTATION OF THE CLIMATE PROOFED RURAL ROADS IN ARID AND SEMI-ARID LANDS (ASAL) - AREA 2.

	Drawing title:				Drawn by	: R.T
		/DE	4 DETAIL C		Designed by	: N.O
	HEADWALL TYPE 1 DETAILS				Checked by	: C.O
					Approved by	: C.O
					Date	: AUGUST, 2023.
ı	Scale: (AS SHOV	WN)	Sheet:		Client approval	:
			2 of 7		Drg No.	: R2000/IMO/2023/PC/01

C9-HEADWALL TYPE 2(DROP INLET)

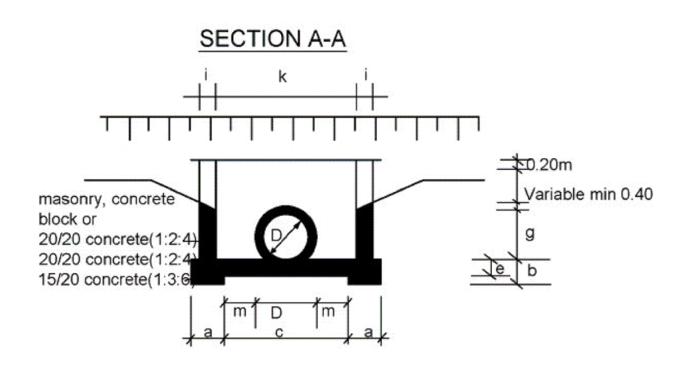

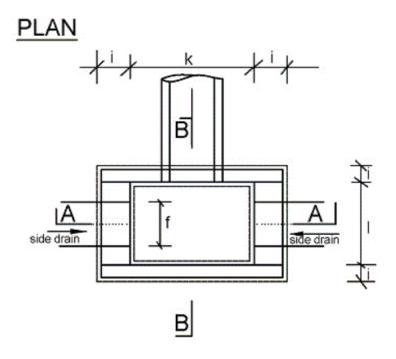

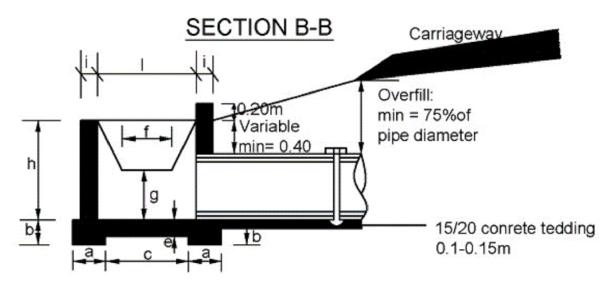

PIPE DIAMETER IN (M)			TYPE A CONCRETE BLOCKS		TYPE B (STONE MASONRY)		NE	
			450	600	900	450	600	900
а	DIMENSION FOUNDATION	UNIT	0.30	0.30	0.30	0.40	0.40	0.40
b	FOUNDATION	m	0.30	0.30	0.30	0.30	0.30	0.30
C	FOUNDATION	m	1.10	1.10	1.40	1.20	1.20	1.50
d	APRON	m	0.90	0.90	0.90	1.00	1.00	1.00
е	APRON	m	0.20	0.20	0.20	0.20	0.20	0.20
f	DROP INLET	m	0.60	0.60	0,60	0.60	0.60	0.60
g	DROP INLET	m	0.30	0.40	0.60	0.30	0.40	0.60
h	DROP INLET	m	0.60	0.80	1.20	0.60	0.80	1.20
i	DROP INLET	m	0.20	0.20	0.20	0.40	0.40	0.40
k	DROP INLET	m	1.20	1.20	1.50	1.20	1.20	1.50
1	DROP INLET	m	1.00	1.00	1.00	1.00	1.00	1.00
m	DROP INLET	m	0.38	0.30	0.30	0.38	0.30	0.30
	ERIAL REQUIREN UNDATION	IENT						
100	oncrete)	m3	0.47	0.47	0.52	0.72	0.72	0.79
HEAD/WINGWALLS (Conrete/Masonry) m3 APRON		0.6	0.72	1.15	1.27	1.63	2.65	
	(cocrete)	m3	0.24	0.24	0.30	0.24	0.24	0.30

NO Revisions:	Date:	Approved By:	Clien
1.			
2.			
			KE









CAS CONSULTANTS LTD
Le'Mac Building, 1st Floor, off

CAS CONSULTANTS LTD

Le'Mac Building, 1st Floor, off Church
Road, Westlands, Nairobi, Kenya
P.O.Box 20023,00200
Tel+254 (020) 4445265, +254722829554
Fmail: info@casconsultants co ke

Project:


DESIGN AND SUPERVISION WORKS FOR IMPLEMENTATION OF THE CLIMATE PROOFED RURAL ROADS IN ARID AND SEMI-ARID LANDS (ASAL) - AREA 2.


AFD/EU/GOK ROADS 2000 CLIMATE PROOFED, AREA
2: ISIOLO, SAMBURU AND MARSABIT COUNTIES


Draw	Drawing title:			Drawn by	: R.T
				Designed by	: N.O
HEADWALL TYPE 2 DETAILS				Checked by	: C.O
				Approved by	: C.O
				Date	: AUGUST, 2023.
Scale:	(AS SHOWN)	Sheet:		Client approval	:
			3 of 7	Dra No.	: R2000/IMO/2023/PC/02

C.10-HEADWALL TYPE 3A (CONCRETE/ BLOCK HEADWALLS

SECTION A-A

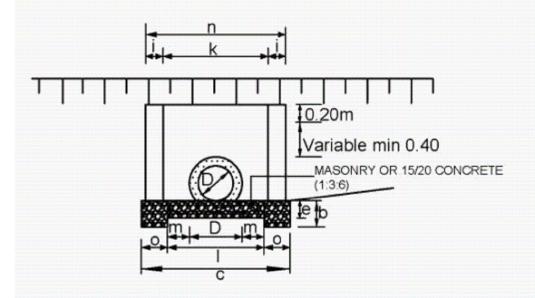

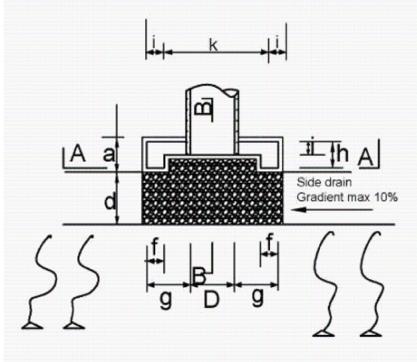

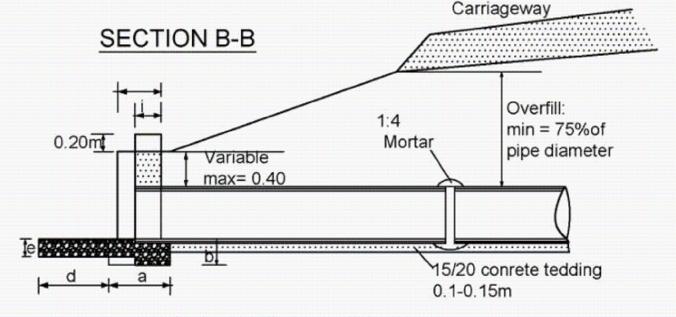

DIMENSIONS AND MATERIAL REQUIREMENTS

	PIPE DIAMETER	CO	PE A and C NCRETE BLO	CKS	
- 1	N (M)	450	600		
	DIMENSION	UNIT			
а	FOUNDATION	m	0.50	0.50	
b	FOUNDATION	m	0.30	0.30	
С	FOUNDATION	m	1.55	1.70	
d	APRON	m	0.60	0.60	
е	APRON	m	0.20	0.20	
f	HEADWALL	m	0.20	0.20	
g	HEADWALL	m	0.50	0.50	
h	HEADWALL	m	0.50	0.50	
i	HEADWALL	m	0.50	0.50	
k	HEADWALL	m	0.50	0.50	
1	FOUNDATION	m	0.50	0.50	
m	FOUNDATION	m	0.50	0.50	
ń	HEADWALL	m	0.50	0.50	
0	FOUNDATION	m	0.50	0.50	
	TERIAL REQUIRE	MENT			
FOUNDATION (concrete)			0.23	0.19	
HEAD/WINGWALLS (Conrete/Masonry) APRON			0.34	0.37	
	(cocrete)		0.95	0.99	

NO Revisions:	Date:	Approved By:	Clien
1.			
2.			
			KE









CAS


CAS CONSULTANTS LTD
Le'Mac Building, 1st Floor, off Church
Road, Westlands, Nairobi, Kenya
P.O. Box 20023,00200
Tel+254 (020) 4445265, +254722829554
Email: info@casconsultants.co.ke


Project:

DESIGN AND SUPERVISION WORKS FOR IMPLEMENTATION OF THE CLIMATE PROOFED RURAL ROADS IN ARID AND SEMI-ARID LANDS (ASAL) - AREA 2.


Prawing title:				Drawn by	: R.T
IE A D	WALL TYPE	2 DETAIL C		Designed by	: N.O
TEAD	WALL TYPE	3 DETAILS		Checked by	: C.O
				Approved by	: C.O
				Date	: AUGUST, 2023.
cale:	(AS SHOWN)			Client approval	:
	4		4 of 7	Drg No.	: R2000/IMO/2023/PC/03

C12- HEADWALL TYPE 4 (FOR ACCESS CULVERTS

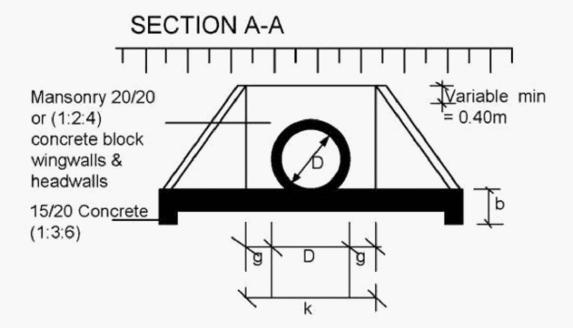

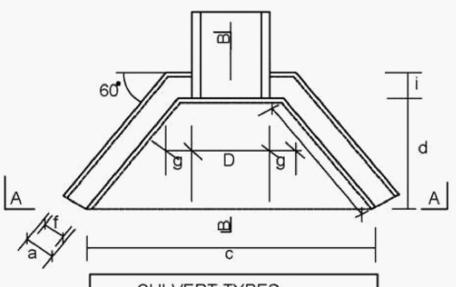

CULVERT TYPES		
X-SECTION WIDTH-M	No. of pipes	
4.50	6.00	
5.50	7.00	
6.50	8.00	

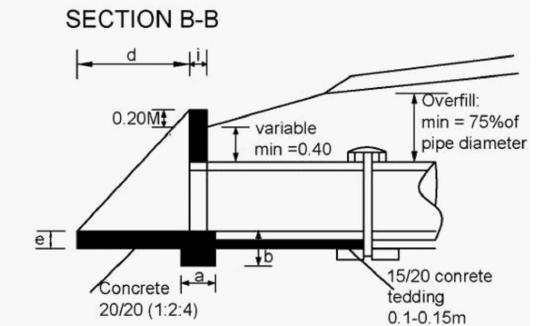

	PIPE DIAMETER IN M			E A CON	CRETE		E B (STO SONRY)	NE
,			450	600	900	450	600	900
а	DIMENSION FOUNDATION	m	0.30	0.30		0.40	0.40	
b	FOUNDATION	m	0.30	0.30		0.30	0.30	
С	FOUNDATION	m	1.34	1.49		1.34	1.49	
d	APRON	m	0.6	0.6		0.60	0.60	
е	APRON	m	0.20	0.20		0.20	0.20	
f	WALL	m	0.20	0.20		0.40	0.40	
g	WALL	m	0.1	0.10		0.10	0.10	
h	WALL	m	0.69	0.69		0.69	0.69	
i	WALL	m	0.20	0.20		0.40	0.40	
k	APRON	m	0.4	0.40		1.05	1.20	
	MATERIAL REQU	JIREMEN	Т		,			
FC	DUNDATION							
(0	oncrete)	m3	0.18	0.2		0.24	0.26	
	EAD/WINGWALLS conrete/Masonry) APRON	m3	0.28	0.32		0.53	0.61	
	(cocrete)	m3	0.12	0.14		0.12	0.14	

NO Revisions:	Date:	Approved By:	Clien
1.			
2.			
			KE













CAS CONSULTANTS LTD Le'Mac Building, 1st Floor, off Church Road, Westlands, Nairobi, Kenya P.O.Box 20023,00200 Tel+254 (020) 4445265, +254722829554

DESIGN AND SUPERVISION WORKS FOR IMPLEMENTATION OF THE CLIMATE PROOFED RURAL ROADS IN ARID AND SEMI-ARID LANDS (ASAL) - AREA 2.

				-
Drawing title:		Drawn by	: R.T	
LIEADWALL TYPE A BETAIL O			Designed by	: N.O
HEADWALL TYPE 1 DETAILS			Checked by	: C.O
		Approved by	: C.O	
			Date	: AUGUST, 2023.
Scale: (AS SHOWN)	Sheet:		Client approval	:
		5 of 7	Dra No	· R2000/IMO/2023/PC/04

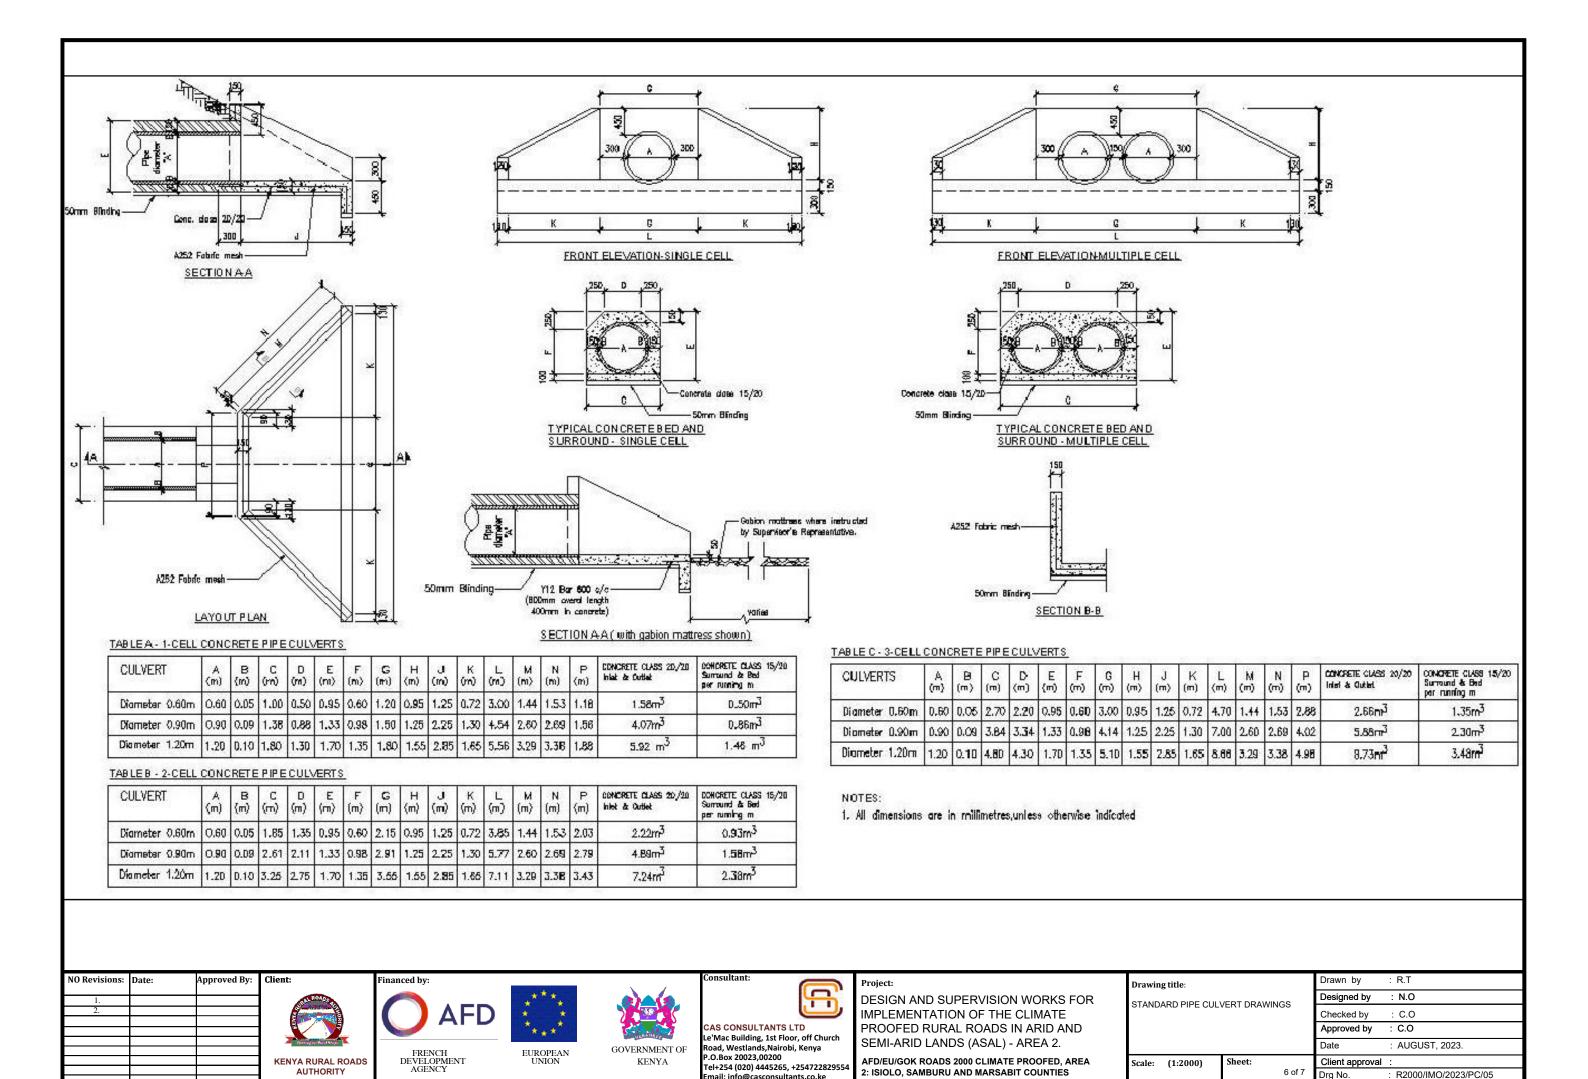

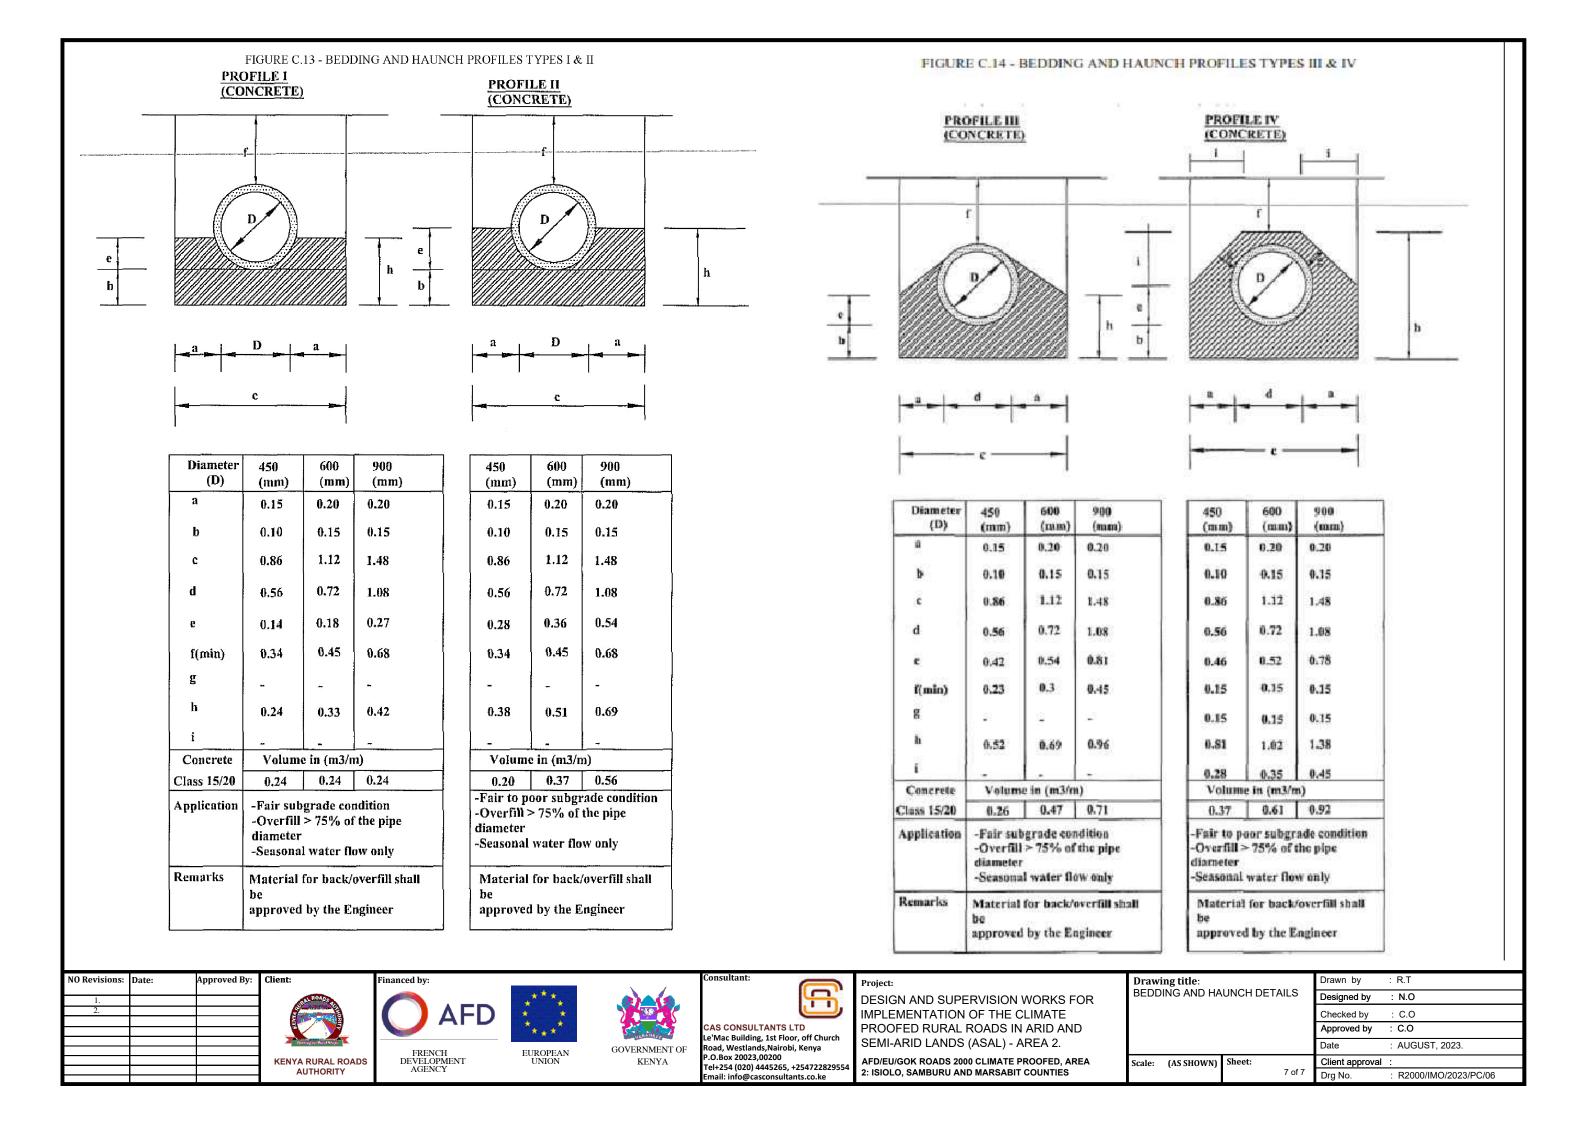

MAJOR DRAINAGE STRUCTURES











AS CONSULTANTS LTD

Le'Mac Building, 1st Floor, off Church P.O.Box 20023.00200

DESIGN AND SUPERVISION WORKS FOR IMPLEMENTATION OF THE CLIMATE PROOFED RURAL ROADS IN ARID AND SEMI-ARID LANDS (ASAL) - AREA 2.

AFD/EU/GOK ROADS 2000 CLIMATE PROOFED, AREA 2: ISIOLO, SAMBURU AND MARSABIT COUNTIES

rawing	title:	

STANDARD DRAWINGS

Scale: (AS SHOWN) Sheet:

Designed by : N.O Approved by : C.O AUGUST, 2023. Client approval

ISIOLO-MLANGO-OLONYIRO ROAD (KM 9+920)

1 CELL 5.0x1.5m BOX CULVERT











CAS CONSULTANTS LTD
Le'Mac Building, 1st Floor, off Church
Road, Westlands, Nairobi, Kenya
P.O.Box 20023,00200
Tel+254 (020) 4445265, +25472282955
Email: info@casconsultants.co.ke

Project:

DESIGN AND SUPERVISION WORKS FOR IMPLEMENTATION OF THE CLIMATE PROOFED RURAL ROADS IN ARID AND SEMI-ARID LANDS (ASAL) - AREA 2.

AFD/EU/GOK ROADS 2000 CLIMATE PROOFED, AREA 2: ISIOLO, SAMBURU AND MARSABIT COUNTIES

Drawing	title


AS SHOWN


1 CELL 5.0x1.5m BOX CULVERT-DETAILS

ISIOLO-MLANGO-OLONYIRO ROAD KM 9+920

Scale: Sheet:

	Drawn by	: P.K
	Designed by	: D.W
	Checked by	: D.W
ΚM	Approved by	: C.O
	Date	: AUGUST, 2023.
	Client approval	:
1	Dra No	· R2000/IMO/2023/CBC

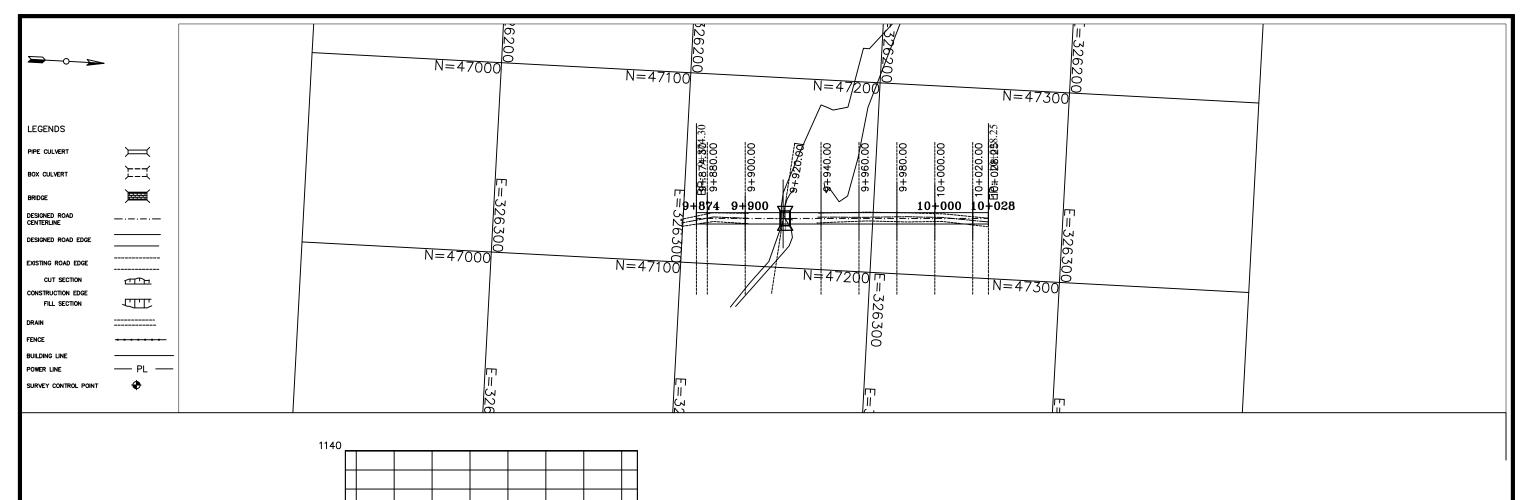

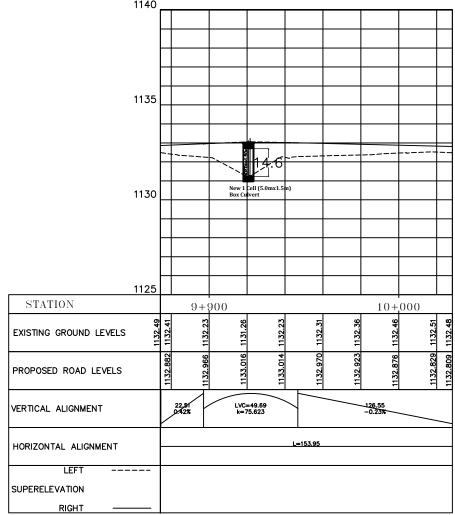

NO Revisions:	Date:	Approved By:	Clie
1.			
2.			
			ĸ

KENYA RURAL ROADS



FRENCH DEVELOPMENT AGENCY









KENYA


AS CONSULTANTS LTD Le'Mac Building, 1st Floor, off Church Road, Westlands,Nairobi, Kenya P.O.Box 20023,00200 Tel+254 (020) 4445265, +254722829554 Email: info@casconsultants.co.ke


DESIGN AND SUPERVISION WORKS FOR IMPLEMENTATION OF THE CLIMATE PROOFED RURAL ROADS IN ARID AND SEMI-ARID LANDS (ASAL) - AREA 2.

Orawing title:		Drawn by	: P.K
PLAN AND PROFILE		Designed by	: N.O
SIOLO-MLANGO-OLONYIRO RD	ии	Checked by	: C.O
0+920		Approved by	: C.O
		Date	: JULY, 2023.
cale: VER 1:100 Sheet:		Client approval	:
HOR 1:1000	of 1	Dra No.	: MTR/PP/01

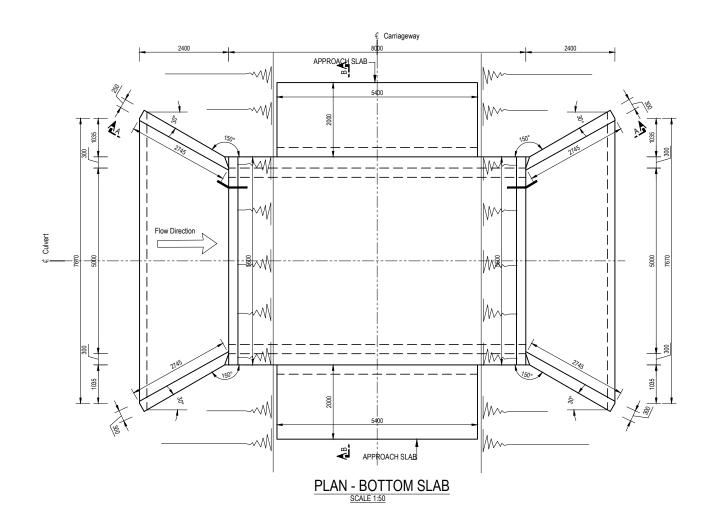


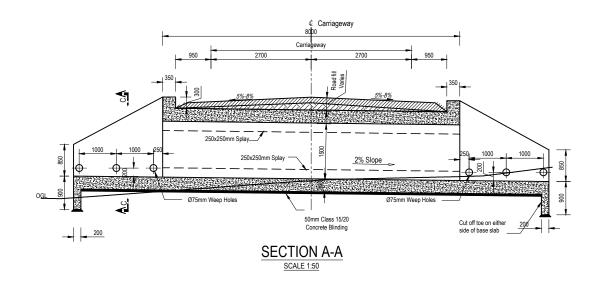

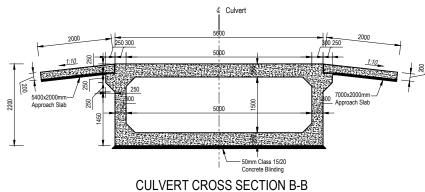

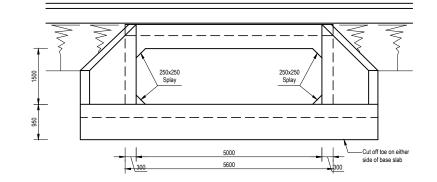

END ELEVATION

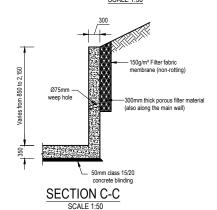

NOTES:

- 1. FINAL CULVERT DIMENSIONS, FORMATION LEVELS & INVERT LEVELS TO BE CONFIRMED ON SITE AT THE TIME OF CONSTRUCTION.
- 2. A TRAFFIC DIVERSION ROUTE WILL BE REQUIRED DURING CONSTRUCTION.
- ALL DIMENSIONS ARE IN MILLIMETRES UNLESS OTHERWISE INDICATED.
 STRUCTURE TO BE PAINTED ON THE OUTER FACES WITH SYNTHETIC ENAMEL PAINT APPROVED BY THE ENGINEER
- 5. INDICATED ROAD LEVELS TO BE CONFIRMED WITH PLAN & PROFILE DRAWINGS

NO Revisions:	Date:	Approved By:	Client:
1.			ROADS
۷.			
			Hydring to Rurol Hough
			KENYA RURAL ROA
			AUTHORITY














DESIGN AND SUPERVISION WORKS FOR IMPLEMENTATION OF THE CLIMATE PROOFED RURAL ROADS IN ARID AND SEMI-ARID LANDS (ASAL) - AREA 2.

Drawing title:			Drawn by	: P.K
1 CELL 5.0x1.5m BOX CULVERT- DETAILS		_	Designed by	: D.W
		-	Checked by	: D.W
ISIOLO-MLANGO-OLONYIRO ROAD KM 9+920			Approved by	: C.O
		Date	: AUGUST, 2023.	
Scale:	Sheet:		Client approval	:
AS SHOWN		1 of 2	Drg No.	: R2000/IMO/2023/CBC/001

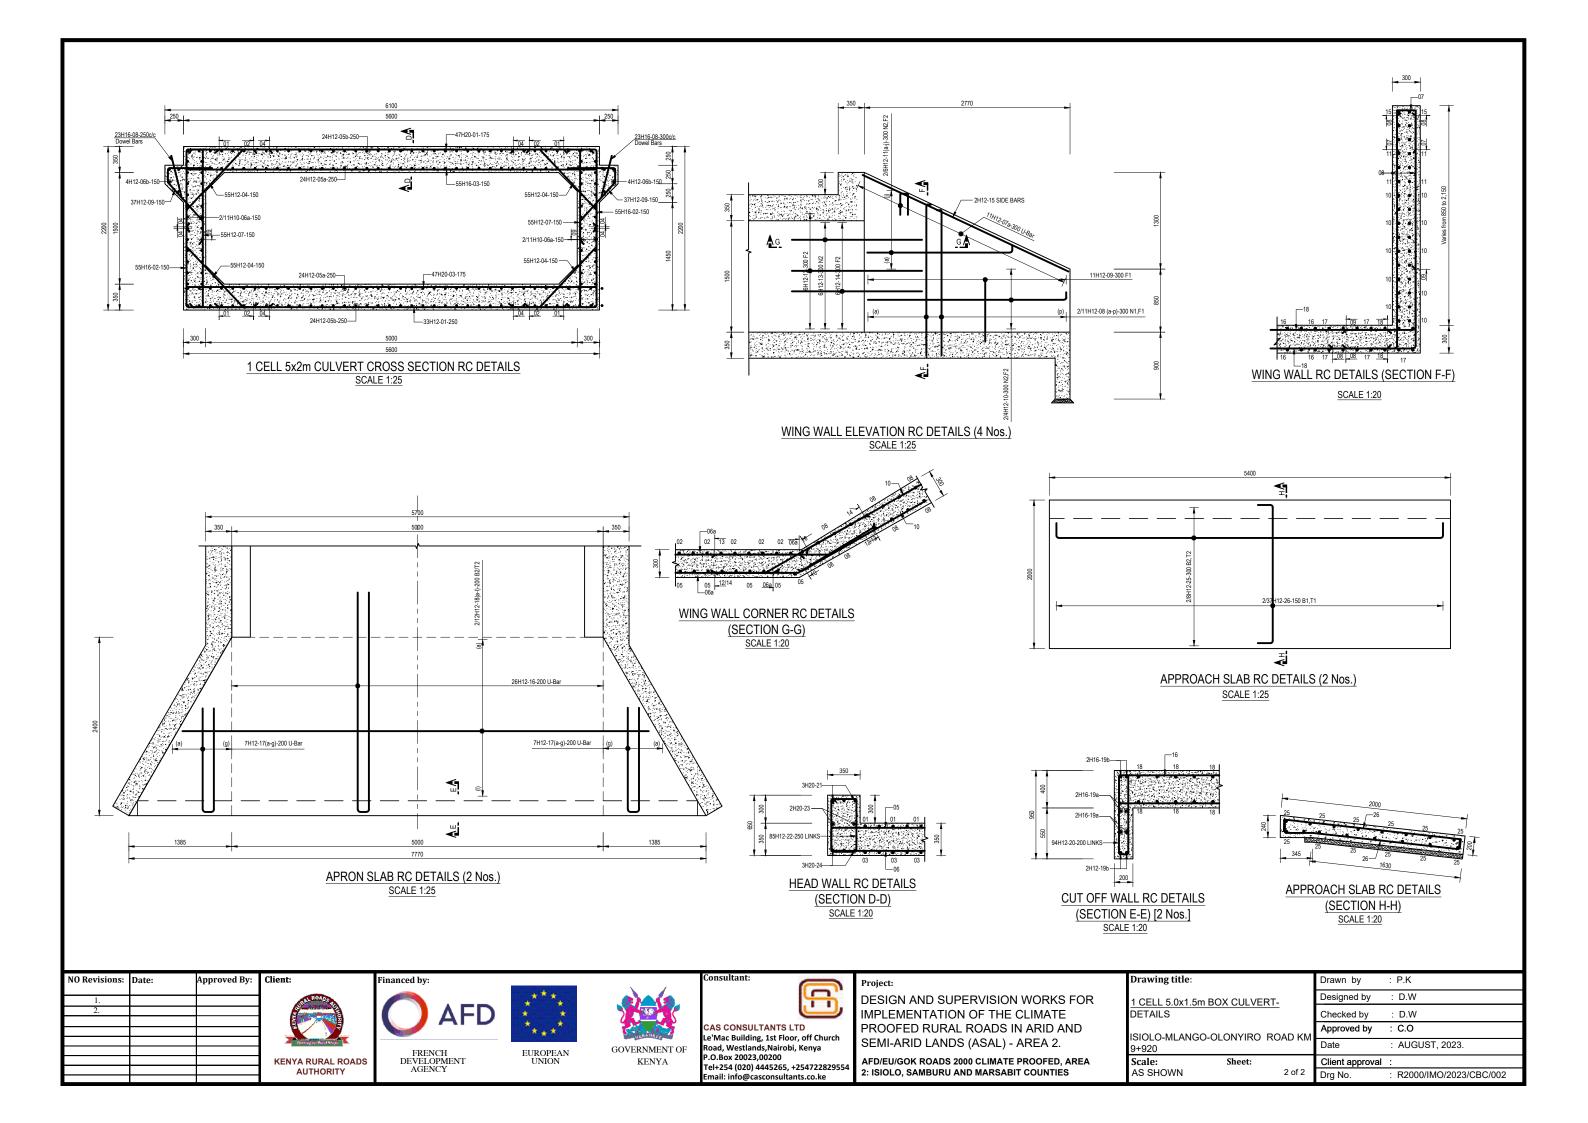

ISIOLO-MLANGO-OLONYIRO ROAD (KM 9+350)

3 CELL 5.0x2.5m BOX CULVERT













DESIGN AND SUPERVISION WORKS FOR IMPLEMENTATION OF THE CLIMATE PROOFED RURAL ROADS IN ARID AND e'Mac Building, 1st Floor, off Church SEMI-ARID LANDS (ASAL) - AREA 2. Road. Westlands, Nairobi, Kenya Tel+254 (020) 4445265, +25472282955


AFD/EU/GOK ROADS 2000 CLIMATE PROOFED, AREA 2: ISIOLO, SAMBURU AND MARSABIT COUNTIES


Drawing title:	
3 CELL 5.0x2.5m BOX CULVER	T.
DETAILS	

AS SHOWN

ISIOLO-MLANGO-OLONYIRO ROAD 9+350 Scale:

	Drawn by	: P.K
	Designed by	: D.W
	Checked by	: D.W
) KM	Approved by	: C.O
	Date	: AUGUST, 2023.
	Client approval	:
of 1	Drg No.	: R2000/GM/2023/CBC

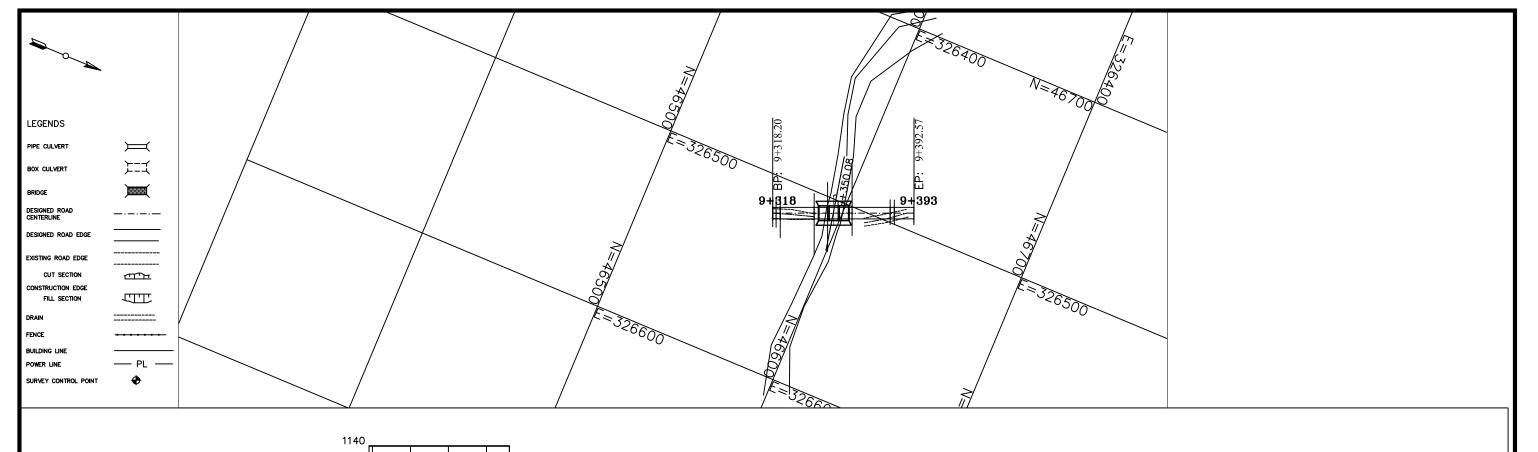

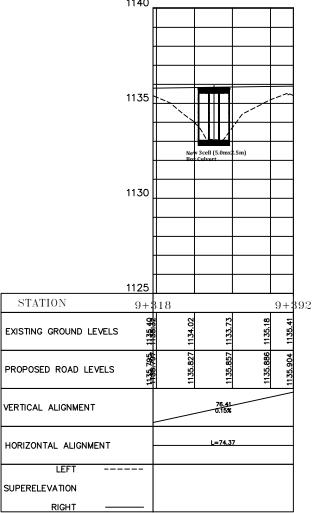

Clie	Approved By:	Date:	NO Revisions:
1			1.
1			2.
ı			
4			
1			
к			













Le'Mac Building, 1st Floor, off Church Road, Westlands,Nairobi, Kenya .O.Box 20023,00200 Tel+254 (020) 4445265, +254722829554 Email: info@casconsultants.co.ke

DESIGN AND SUPERVISION WORKS FOR IMPLEMENTATION OF THE CLIMATE PROOFED RURAL ROADS IN ARID AND SEMI-ARID LANDS (ASAL) - AREA 2.

Drawing title:		Drawn by	: P.K
PLAN AND PROFILE		Designed by	: N.O
ISIOLO-MLANGO-C	I ONVIDO DO KM	Checked by	: C.O
9+350	LONTING RD RM	Approved by	: C.O
		Date	: JULY, 2023.
Scale: VER 1:100	Sheet:	Client approval	:
HOR 1:1000	1 of 1	Drg No.	: MTR/PP/01

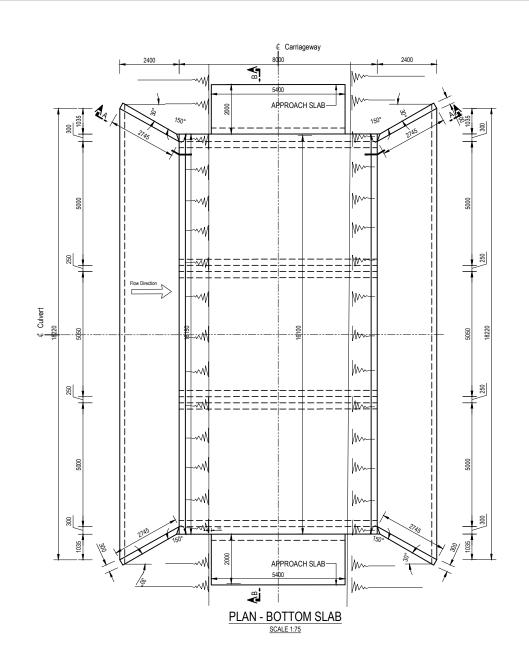


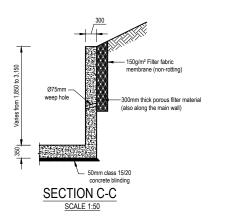



NOTES:

- 1. FINAL CULVERT DIMENSIONS, FORMATION LEVELS & INVERT LEVELS TO BE CONFIRMED ON SITE AT THE TIME OF CONSTRUCTION.
 2. A TRAFFIC DIVERSION ROUTE WILL BE REQUIRED DURING CONSTRUCTION.
 3. ALL DIMENSIONS ARE IN MILLIMETRES UNLESS OTHERWISE INDICATED.

- 4. STRUCTURE TO BE PAINTED ON THE OUTER FACES WITH SYNTHETIC ENAMEL PAINT APPROVED BY THE ENGINEER
- 5. INDICATED ROAD LEVELS TO BE CONFIRMED WITH PLAN & PROFILE DRAWINGS

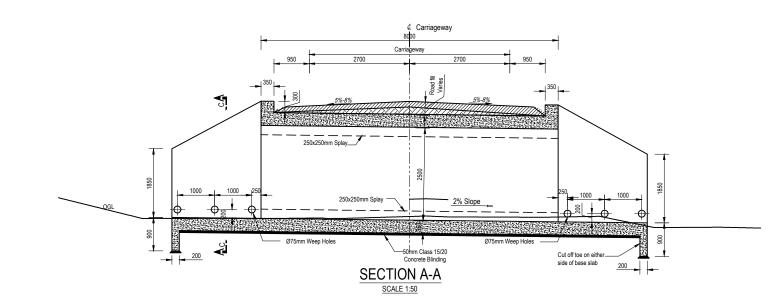

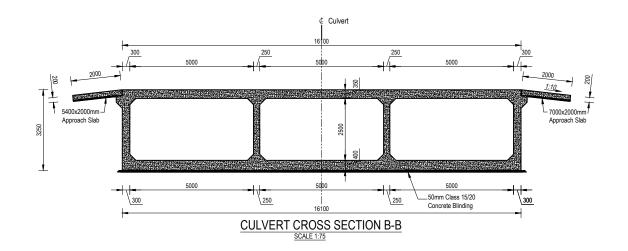

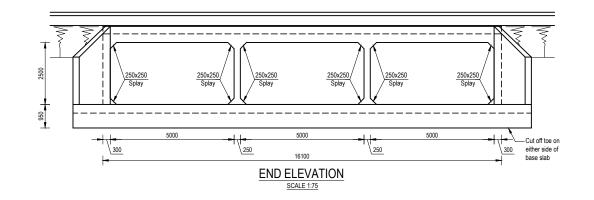



KENYA RURAL ROADS AUTHORITY









CAS CONSULTANTS LTD Le'Mac Building, 1st Floor, off Church Road, Westlands, Nairobi, Kenya P.O.Box 20023,00200 Tel+254 (020) 4445265, +254722829554 Project:

DESIGN AND SUPERVISION WORKS FOR IMPLEMENTATION OF THE CLIMATE PROOFED RURAL ROADS IN ARID AND SEMI-ARID LANDS (ASAL) - AREA 2.

Drawing title:			Drawn by	:	P.K
3 CELL 5.0x2.5m	BOX CUI VER	т-	Designed by	:	D.W
DETAILS			Checked by	:	D.W
ISIOLO-MLANGO		OAD KM	Approved by	:	C.O
ISIOLO-MLANGO-OLONYIRO ROAD KM 9+350		CAD KW	Date	:	AUGUST, 2023.
Scale:	Sheet:		Client approval	:	
AS SHOWN		1 of 3	Drg No.	:	R2000/IMO/2023/CBC/002/1

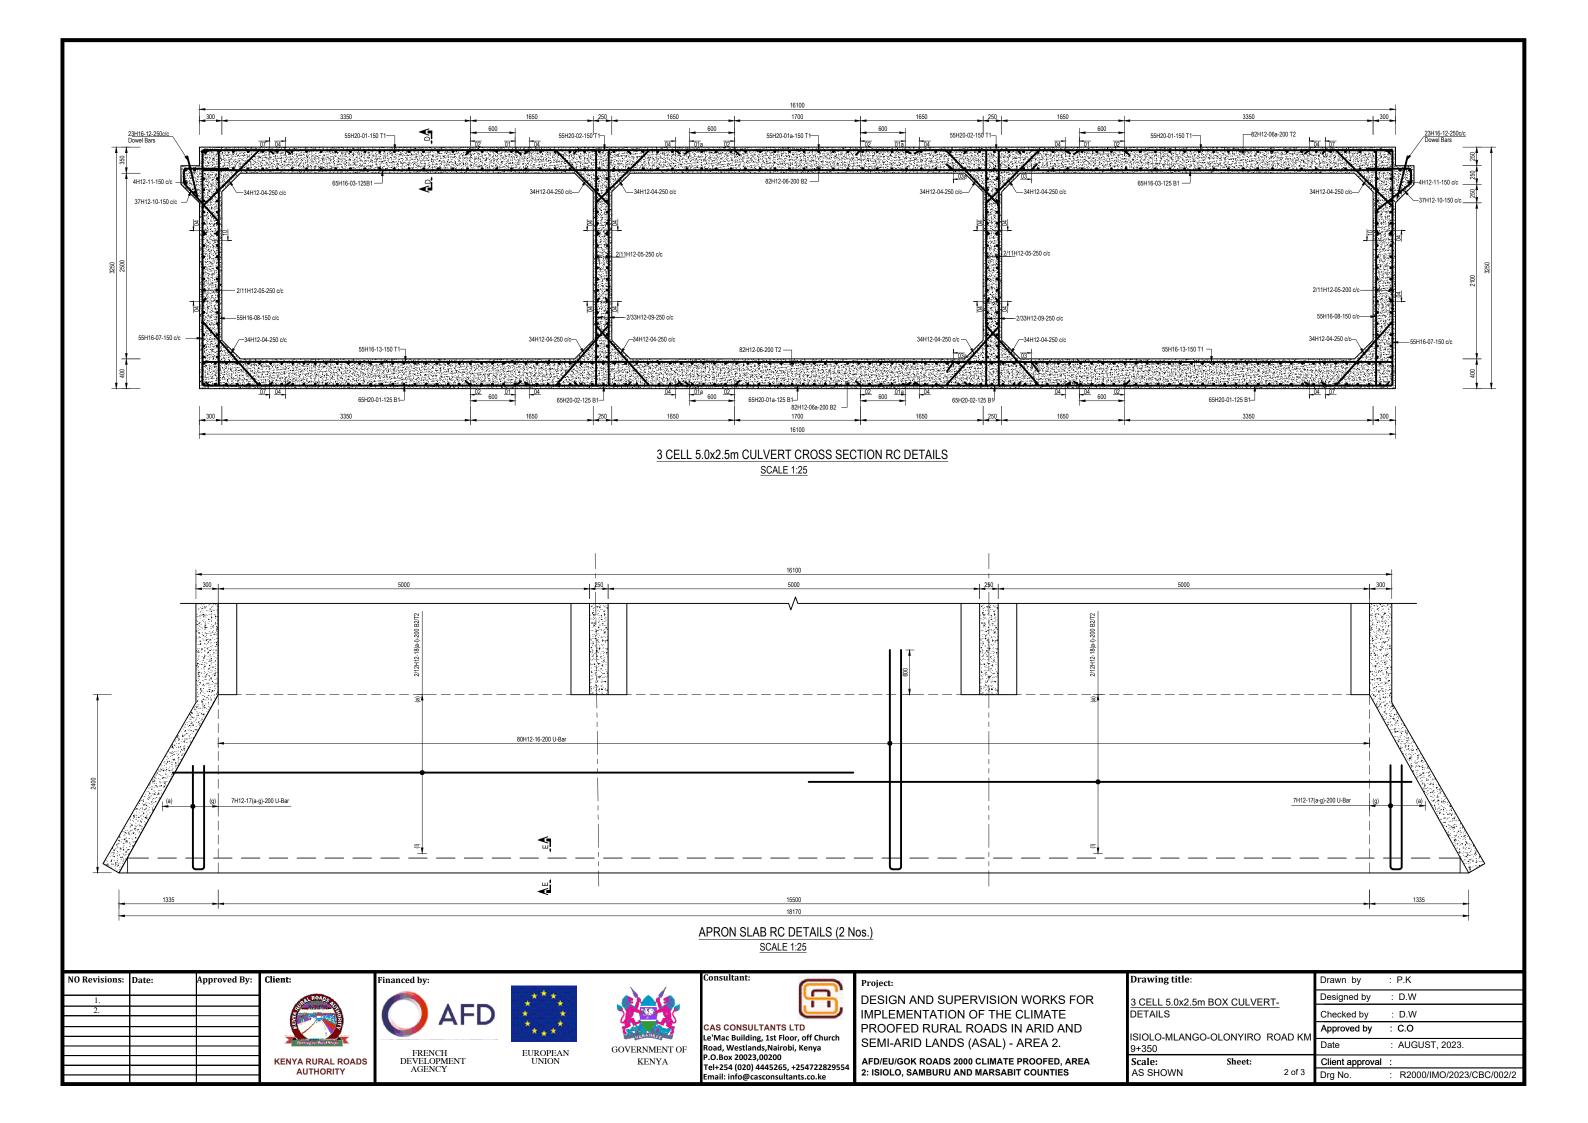

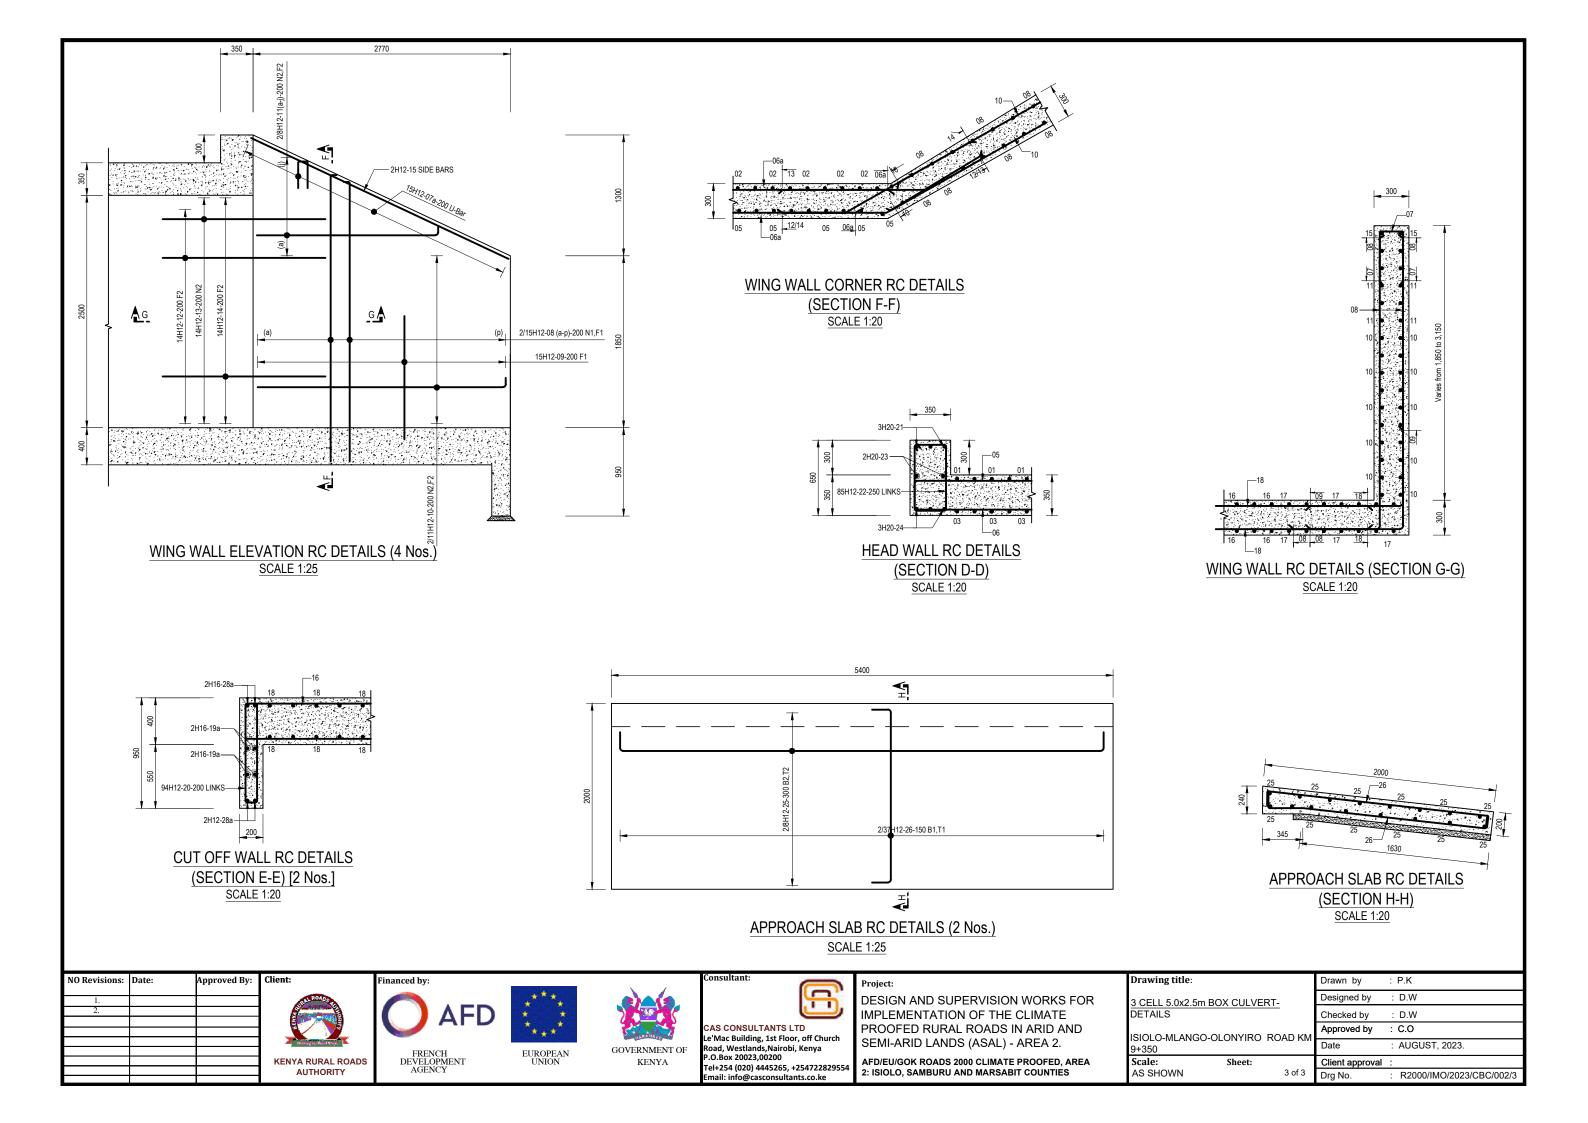

ISIOLO-MLANGO-OLONYIRO ROAD (KM 17+070)

30M LONG DRIFT













e'Mac Building, 1st Floor, off Church Road. Westlands, Nairobi, Kenya Tel+254 (020) 4445265, +25472282955

DESIGN AND SUPERVISION WORKS FOR IMPLEMENTATION OF THE CLIMATE PROOFED RURAL ROADS IN ARID AND SEMI-ARID LANDS (ASAL) - AREA 2.


2: ISIOLO, SAMBURU AND MARSABIT COUNTIES

Drawing title:
30M LONG DRIFTS DETAILS ROAD

D.W Checked by D.W Approved by ISIOLO-MLANGO-OLONYIRO KM 17+070 C.O AUGUST, 2023.

AFD/EU/GOK ROADS 2000 CLIMATE PROOFED, AREA

Scale: AS SHOWN

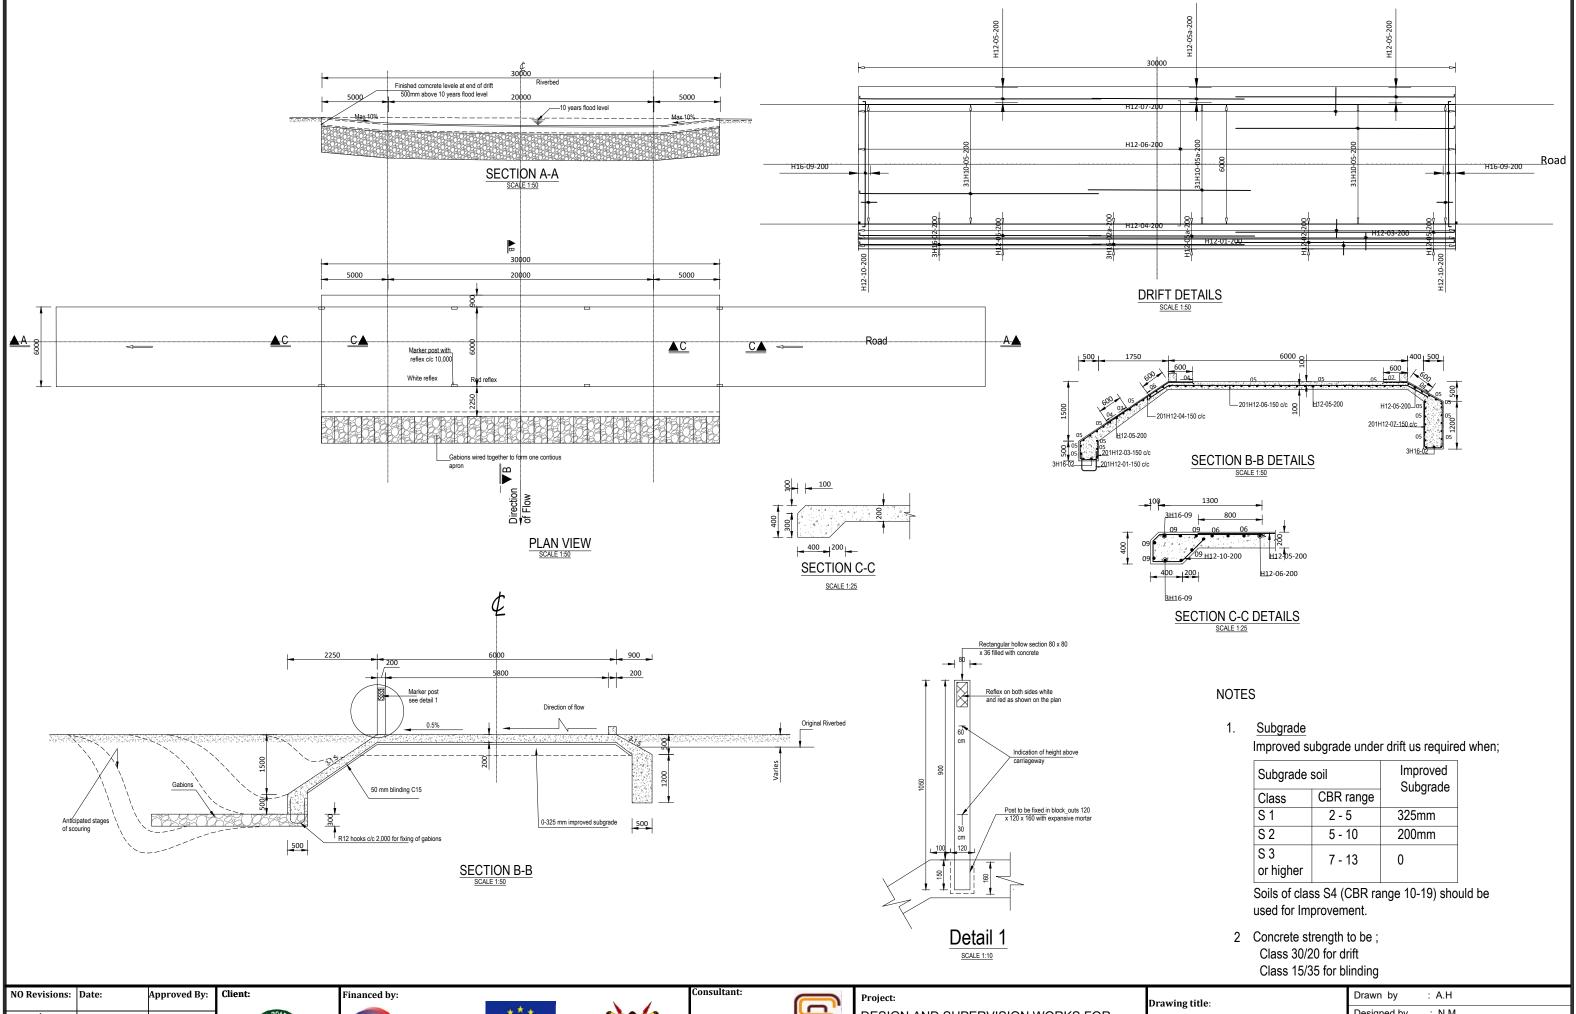

: N.M Designed by DESIGN AND SUPERVISION WORKS FOR IMPLEMENTATION OF THE CLIMATE : D.W Checked by 30M LONG DRIFTS DETAILS ROAD CAS CONSULTANTS LTD PROOFED RURAL ROADS IN ARID AND : C.O Approved by ISIOLO-MLANGO-OLONYIRO KM 17+070 e'Mac Building, 1st Floor, off Church SEMI-ARID LANDS (ASAL) - AREA 2. : AUGUST, 2023. Date EUROPEAN UNION GOVERNMENT OF FRENCH DEVELOPMENT AGENCY P.O.Box 20023,00200 AFD/EU/GOK ROADS 2000 CLIMATE PROOFED, AREA Client approval **KENYA RURAL ROADS** Tel+254 (020) 4445265, +254722829554 **AUTHORITY** 2: ISIOLO, SAMBURU AND MARSABIT COUNTIES AS SHOWN 1 of 1 MTR/DRT/001

STANDARD DRAWINGS













CAS CONSULTANTS LTD
Le'Mac Building, 1st Floor, off Church
Road, Westlands, Nairobi, Kenya
P.O.Box 20023,00200
Tel+254 (020) 4445265, +254722829554
Email: info@casconsultants.co.ke

Project:

DESIGN AND SUPERVISION WORKS FOR IMPLEMENTATION OF THE CLIMATE PROOFED RURAL ROADS IN ARID AND SEMI-ARID LANDS (ASAL) - AREA 2.


AFD/EU/GOK ROADS 2000 CLIMATE PROOFED, AREA 2: ISIOLO, SAMBURU AND MARSABIT COUNTIES


Drawing	title:	


STANDARD DRAWINGS

Scale: (AS SHOWN) Sheet:

	Drawn by	: R.T
	Designed by	: N.O
	Checked by	: C.O
	Approved by	: C.O
	Date	: AUGUST, 2023.
	Client approval	:
of 5		

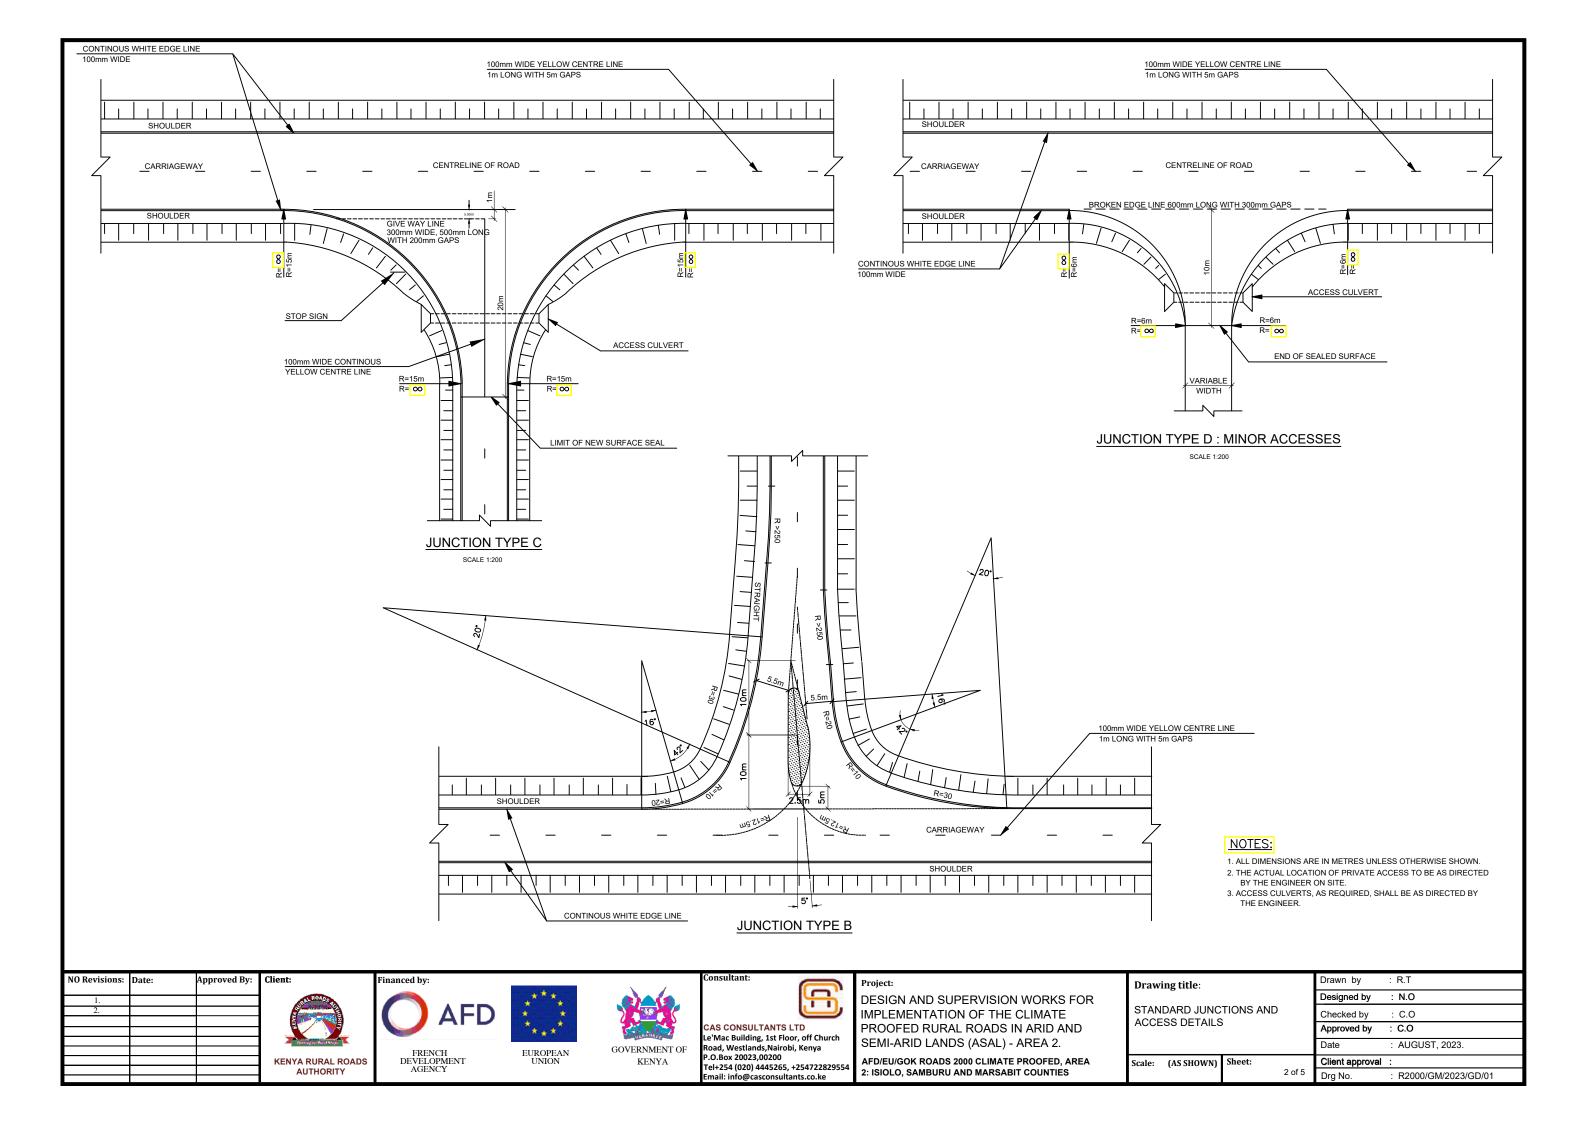

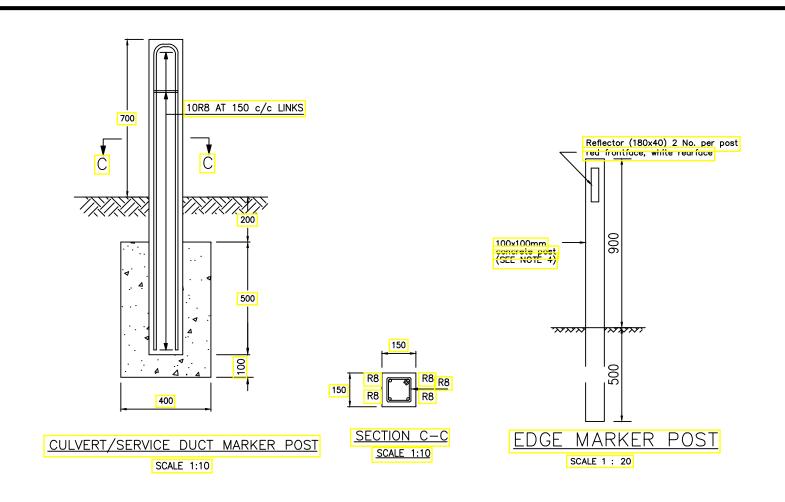


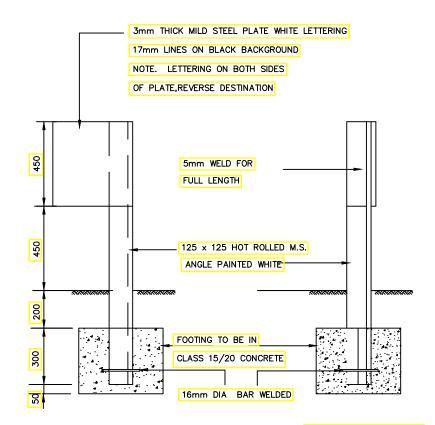

FRONT ELEVATION

SIDE ELEVATION

KILOMETER MARKER POST SCALE 1 : 20

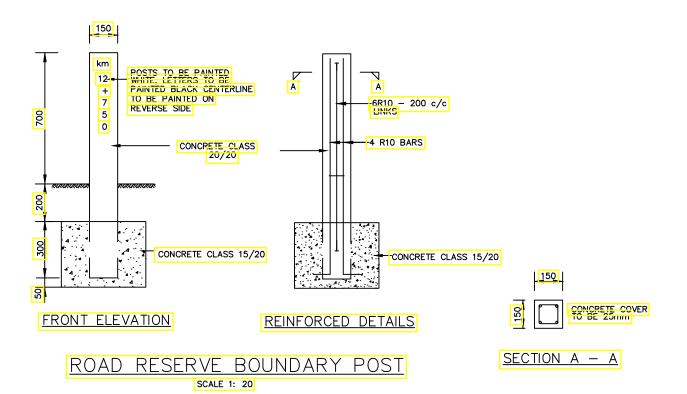

NOTES

1. Edge marker posts

- To be provided both sides of carriageway in the following cases:-
- a). Embankments of height 2m or above where guardrail is not provided
- b). As shown in the contract dwgs or directed by the Engineer.
- 3. Alternative edge marker post design can be submitted to Engineer for approval
- 4. The distance between edge marker posts to be 50m. On curves, the distance to be reduced to 25m. On hills, distance to be 25m. Where there is limited sight distance, this distance must be reduced so that at least 5 posts are visible.
- 5. All dimensions in MM

NO Revisions:	Date:	Approved By:	Client:
1.	<u> </u>	-	AN ROADS
2.			Drg No.
		+	
			Opening up Rural Resp
			KENYA RURAL
			AUTHORIT

ROADS








-AS CONSULTANTS LTD e'Mac Building, 1st Floor, off Church oad, Westlands, Nairobi, Kenya P.O.Box 20023.00200 Tel+254 (020) 4445265, +254722829554 Project:

DESIGN AND SUPERVISION WORKS FOR IMPLEMENTATION OF THE CLIMATE PROOFED RURAL ROADS IN ARID AND SEMI-ARID LANDS (ASAL) - AREA 2.

Drawing title:				Drawn by	: R.T
CTANDADD DDAWINGC				Designed by	: N.O
STANDARD DRAWINGS				Checked by	: C.O
STANDARD MARKER POST DETAILS			T	Approved by	: C.O
				Date	: AUGUST, 2023.
Scale:	(1:2000)	Sheet:		Client approval	:
			4 of 5	Drg No.	: R2000/GM/2023/GD/03

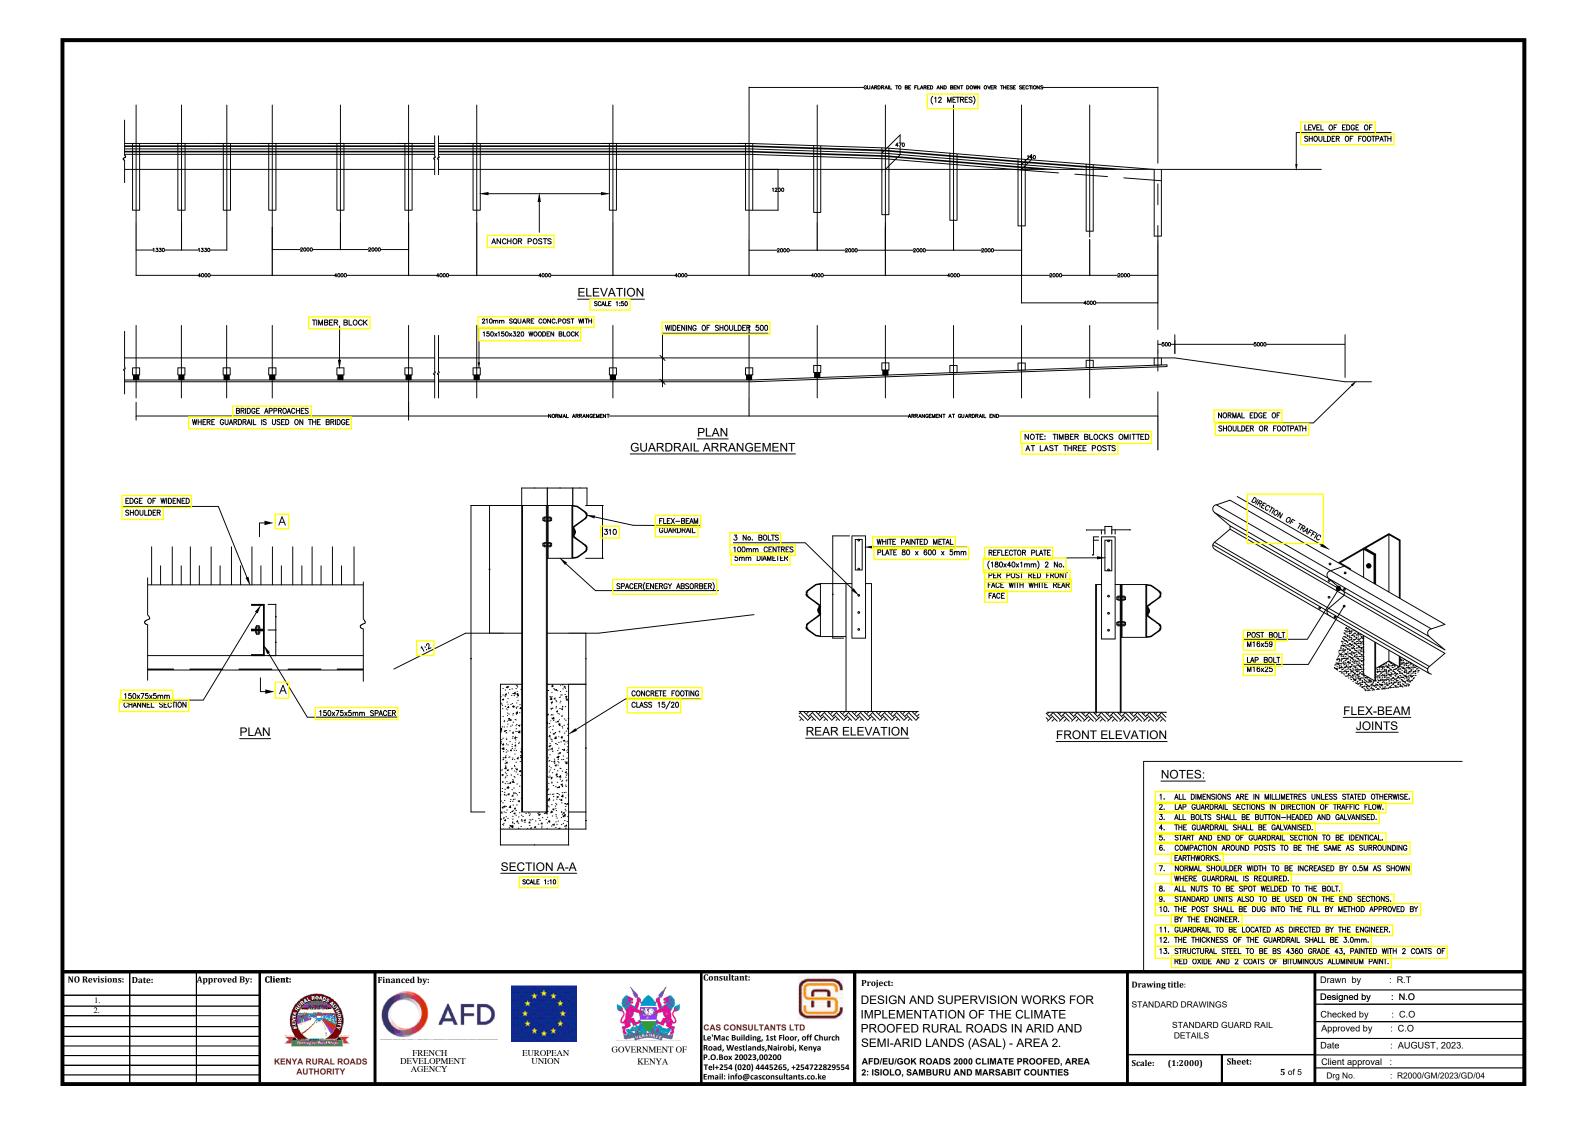

GENERAL DRAINAGE















CAS CONSULTANTS LTD Le'Mac Building, 1st Floor, off Church Road, Westlands, Nairobi, Kenya P.O.Box 20023,00200 Tel+254 (020) 4445265, +254722829554 Project:

DESIGN AND SUPERVISION WORKS FOR IMPLEMENTATION OF THE CLIMATE PROOFED RURAL ROADS IN ARID AND SEMI-ARID LANDS (ASAL) - AREA 2.

Drawing title:	Orawing title:		Drawn by	: R.T
GENERAL DRAINAGE			Designed by	: N.O
			Checked by	: C.O
			Approved by	: C.O
			Date	: AUGUST, 2023.
Scale: (1:2000)	Sheet:		Client approval	:
-		1 of C		

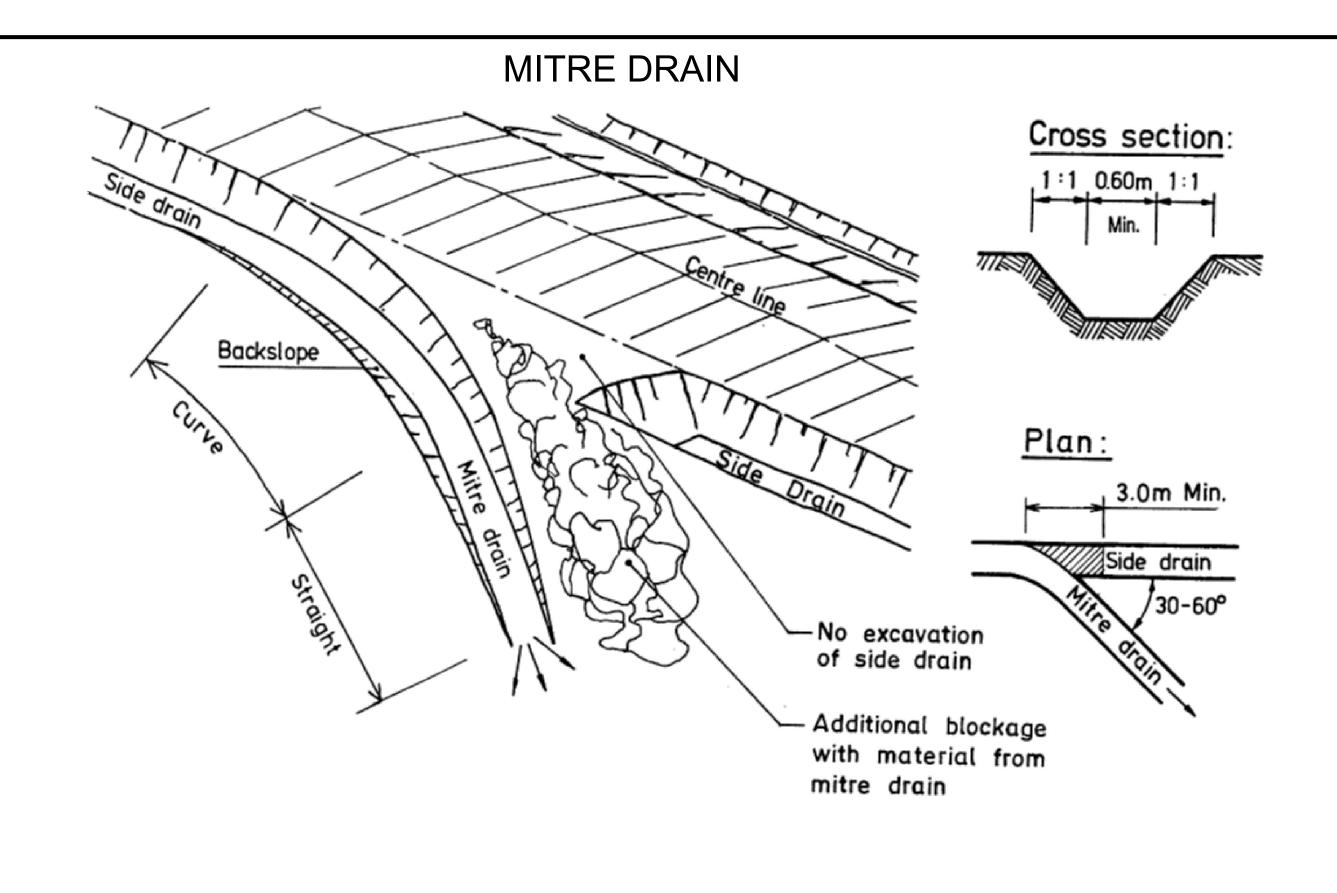

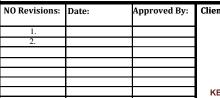











CAS CONSULTANTS LTD
Le'Mac Building, 1st Floor, off Church
Road, Westlands, Nairobi, Kenya
P.O.Box 20023,00200
Tel+254 (020) 4445265, +254722829554


Project

DESIGN AND SUPERVISION WORKS FOR IMPLEMENTATION OF THE CLIMATE PROOFED RURAL ROADS IN ARID AND SEMI-ARID LANDS (ASAL) - AREA 2.


Prawing title: MITRE DRAINS DETAILS			Drawn by	: R.T
			Designed by	: N.O
			Checked by	: C.O
			Approved by	: C.O
		Date	: AUGUST, 2023.	
cale: (1:2000)	000) Sheet:		Client approval	:
		2 of 6	Drg No.	: R2000/IMO/2023/GD/01

SCOUR CHECKS



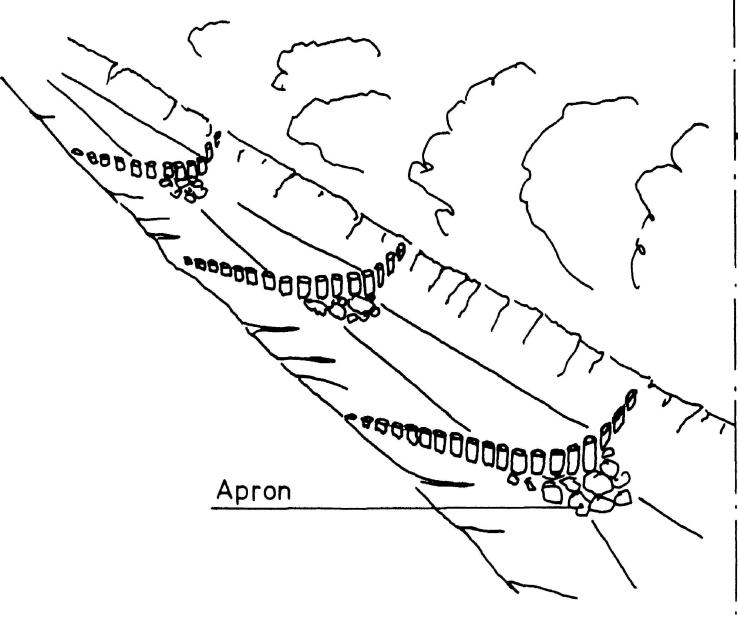

Scour checks made of stones:

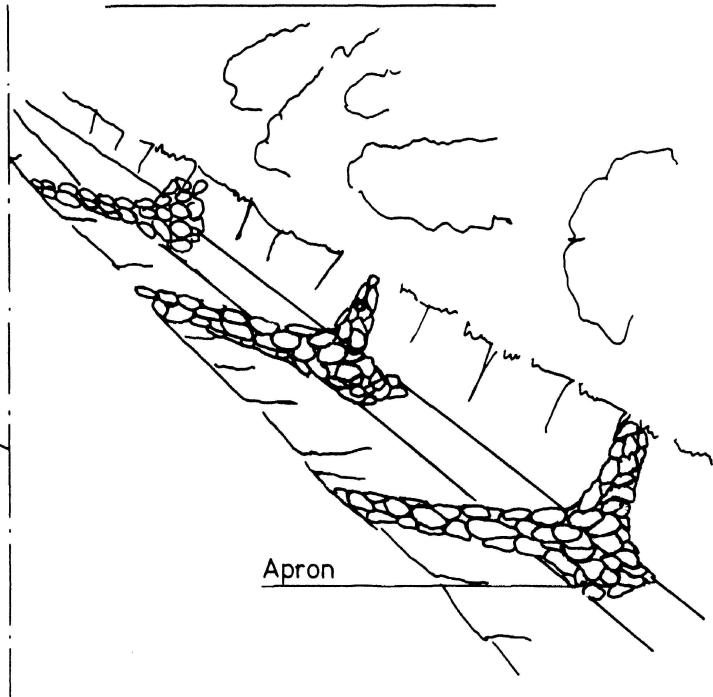

NO Revisions:	Date:	Approved By:	Client
1.			
2.			
			2
·			KEN











CAS CONSULTANTS LTD

Le'Mac Building, 1st Floor, off Church
Road, Westlands, Nairobi, Kenya
P.O.Box 20023, 00200

Tel+254 (020) 4445265, +254722829554


Project:

DESIGN AND SUPERVISION WORKS FOR IMPLEMENTATION OF THE CLIMATE PROOFED RURAL ROADS IN ARID AND SEMI-ARID LANDS (ASAL) - AREA 2.

Drawing title:			Drawn by	: R.T
SCOUR CHECKS			Designed by	: N.O
SCOOK CHECKS			Checked by	: C.O
			Approved by	: C.O
			Date	: AUGUST, 2023.
Scale: (1:2000)	Sheet:		Client approval	:
		3 of 6	Drg No.	: R2000/IMO/2023/GDR/02

Scour checks made of stones

Scour checks made of wooden stakes

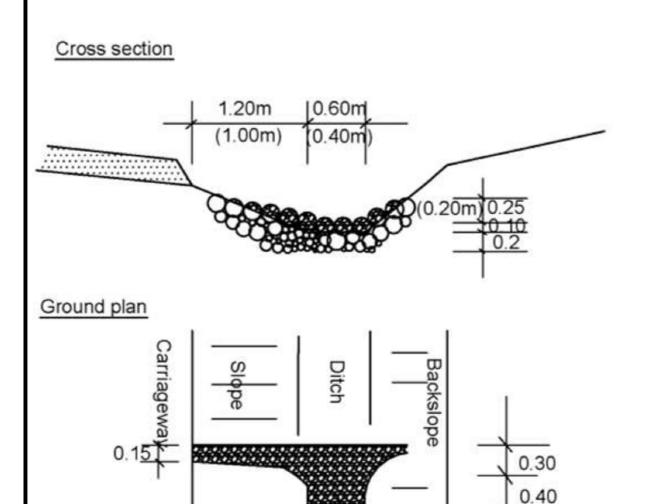


Stone

apron


erosion

STONE WEIGHT: MIN 10KG

Cross section

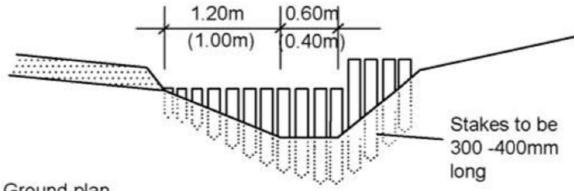

Ground plan

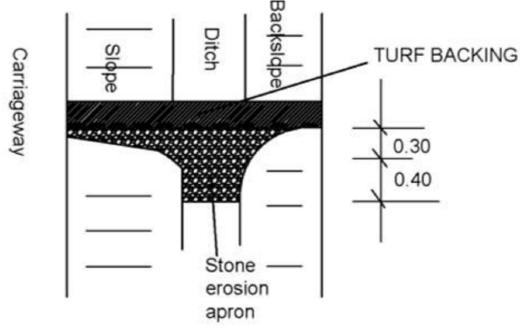

NOTE 1Dimensions in metres

NO Revisions:	Date:	Approved By:	Clie
1.			
2.			

KENYA RURAL ROADS AUTHORITY










STAKE DIAMETER: MIN. 0.10m


e'Mac Building, 1st Floor, off Church Road, Westlands, Nairobi, Kenya P.O.Box 20023,00200 Tel+254 (020) 4445265, +254722829554

DESIGN AND SUPERVISION WORKS FOR IMPLEMENTATION OF THE CLIMATE PROOFED RURAL ROADS IN ARID AND SEMI-ARID LANDS (ASAL) - AREA 2.

Drawing title:		Drawn by : R.T
SCOUR CHECKS		Designed by : N.O
SCOOK CHECKS		Checked by : C.O
		Approved by : C.O
		Date : AUGUST, 2023.
Scale: (1:2000)	Sheet:	Client approval :
	4 of 6	Drg No. : R2000/IMO/2023/GDR/03

- MASONRY SCOUR CHECKS 2400 (2000) ÇARRIAGEWAY 300 J₂300 1200 A (400) (1000)250 400 300 $\mathsf{A} \supset$ A - A A SECTION OF MASONRY SCOUR CHECKS ~W SLOPE BACKSLOPE **~**₩ CARRIAGEWAY 200 BACKSLOPE 400 SLOPE **~**₩ PLAN OF DRAIN WITH EROSION CHECKS **QUANTITIES TABLE** Sizes in mm Stone Excav. (m3) Apron stone Crossmasonry pitching (m3) Section (m3) Depth Length Width 2400 200 550 0.22 0.25 0.18 Α В 200 500 2000 0.18 0.2 0.14 NO Revisions: Date: Client: pproved By: Drawn by : R.T Project: Drawing title: **F** : N.O Designed by DESIGN AND SUPERVISION WORKS FOR SCOUR CHECKS IMPLEMENTATION OF THE CLIMATE C.O AS CONSULTANTS LTD PROOFED RURAL ROADS IN ARID AND : C.O Approved by e'Mac Building, 1st Floor, off Church SEMI-ARID LANDS (ASAL) - AREA 2. : AUGUST ,2023. oad, Westlands, Nairobi, Kenya GOVERNMENT OF FRENCH DEVELOPMENT AGENCY EUROPEAN UNION P.O.Box 20023.00200 AFD/EU/GOK ROADS 2000 CLIMATE PROOFED, AREA KENYA RURAL ROADS Sheet: KENYA Client approval Scale: (1:2000) Tel+254 (020) 4445265, +254722829554 AUTHORITY 2: ISIOLO, SAMBURU AND MARSABIT COUNTIES **5** of 6 : R2000/IMO/2023/GDR/04 Drg No.

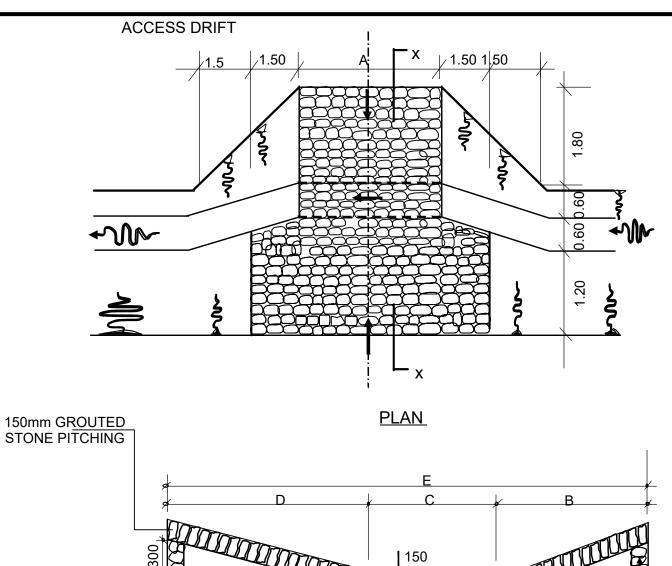

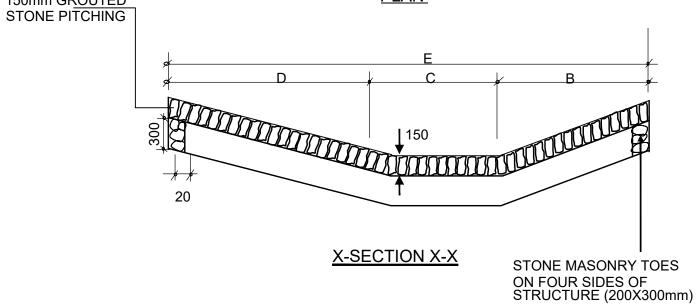

QUANTITIES TABLE								
Cross		DIME	ENSI	ONS			Stone masonry (m3)	150mm Grouted stone
section	Α	В	С	D	Е	Excavation (m3)	(mo)	pitching (m3)
•	4000	1800	600	1800	4200	7.50	1.30	21.75
Α	6000	1800	600	1800	4200	10.00	1.60	30.15
_	4000	1400	400	1800	3600	7.00	1.20	18.30
В	6000	1400	400	1800	3600	9.00	1.50	25.50

NO Revisions: Date: Approved By: Client:












CAS CONSULTANTS LTD
Le'Mac Building, 1st Floor, off Church
Road, Westlands, Nairobi, Kenya
P.O.Box 20023,00200
Tel+254 (020) 4445265, +254722829554
Email: info@casconsultants.co.ke

Project:

DESIGN AND SUPERVISION WORKS FOR IMPLEMENTATION OF THE CLIMATE PROOFED RURAL ROADS IN ARID AND SEMI-ARID LANDS (ASAL) - AREA 2.

. 1	AFD/EU/GOK ROADS 2000 CLIMATE PROOFED, AREA
1	2: ISIOLO, SAMBURU AND MARSABIT COUNTIES

Prawing title:		Drawn by	: R.T	
TANDARD DRAWINGS ACCESS DRIFT DETAILS			Designed by	: N.O
			Checked by	: C.O
			Approved by	: C.O
			Date	: AUGUST ,2023.
cale: (1:2000)	Sheet:		Client approval :	
		6 of 7	Dra No	· P2000/IMO/2022/CDP/05

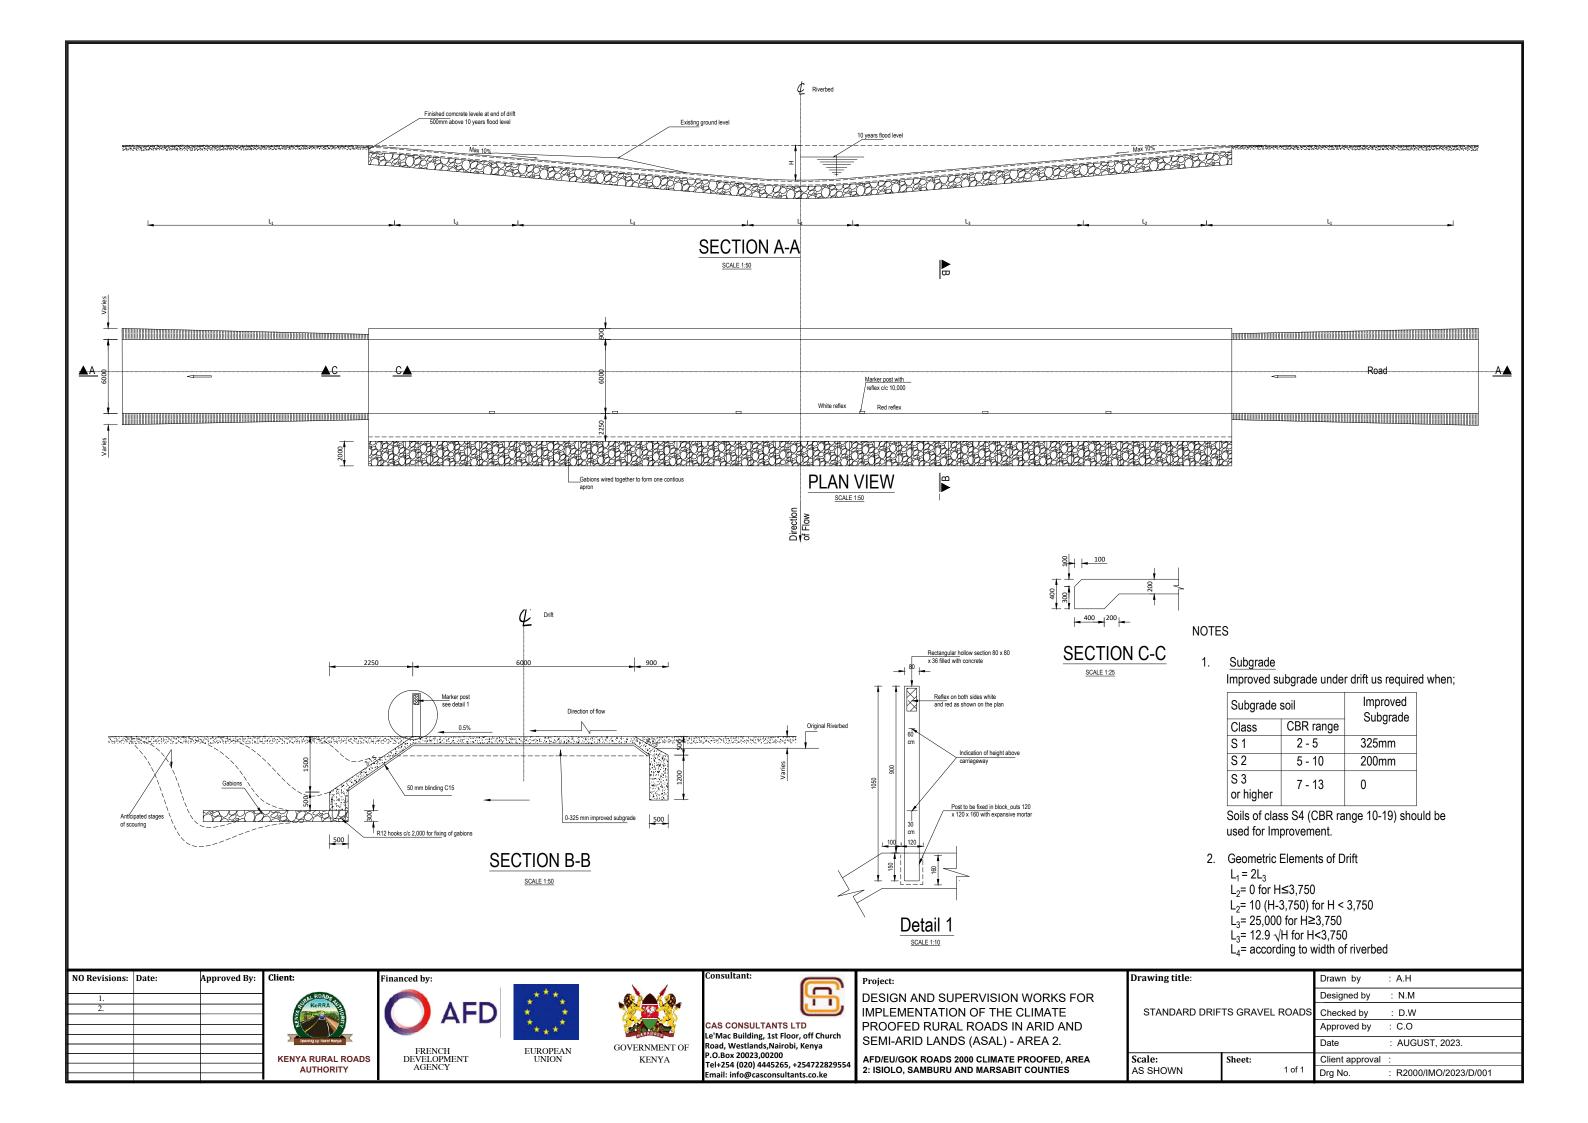

TRAFFIC SIGNS












onsultant:		
[[_ ,	
	П,	
•		
AS CONSULTANTS LTD		

CAS CONSULTANTS LTD
Le'Mac Building, 1st Floor, off Church
Road, Westlands, Nairobi, Kenya
P.O. Box 20023,00200
AF
Tel+254 (020) 4445265, +254722829554
Email: info@casconsultants.co.ke

Project:

DESIGN AND SUPERVISION WORKS FOR IMPLEMENTATION OF THE CLIMATE PROOFED RURAL ROADS IN ARID AND SEMI-ARID LANDS (ASAL) - AREA 2.

Drawing title:		Drawn by	: R.T
TRAFFIC SIGNS		Designed by	: N.O
TRAFFIC SIGNS		Checked by	: C.O
		Approved by	: C.O
		Date	: AUGUST, 2023.
Scale: (1:2000)	Sheet:	Client approval	:
	1 of 2		

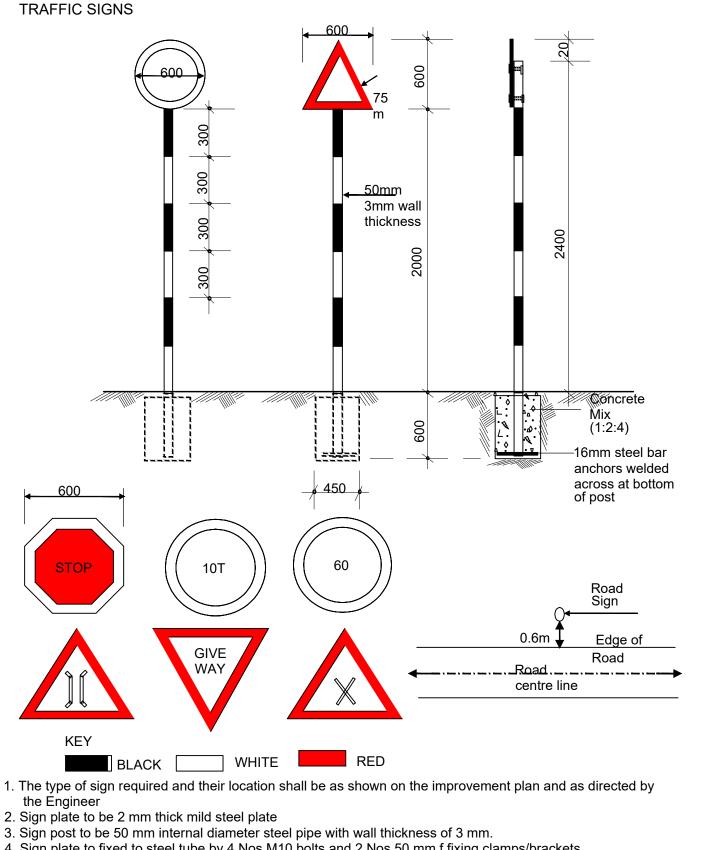

TEMPORARY SIGNS








"Road narrows on Right Ahead"(sign may be reversed)



"Turn Left" (direction of arrow may be reversed)




"Keep Left" (direction of Arrow may be reversed)

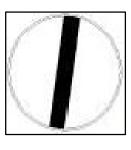

"Road Clear"




"Speed Limit"

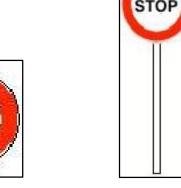




GO

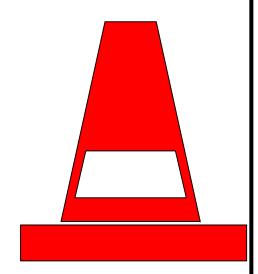

Traffic cones

- 4. Sign plate to fixed to steel tube by 4 Nos M10 bolts and 2 Nos 50 mm f fixing clamps/brackets.
- 5. Sign paints shall be reflective.
- 6. The sign plate and post shall be treated by applying two coats of lead red oxide paint before applying priming and two finish coats of approved paints. Paints used shall have a hard, durable and glossy finish.

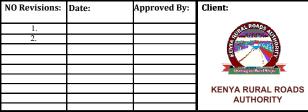









AS CONSULTANTS LTD

n e'Mac Building, 1st Floor, off Church Road, Westlands, Nairobi, Kenya P.O.Box 20023,00200

Tel+254 (020) 4445265, +254722829554

Project:

"No Overtaking"

DESIGN AND SUPERVISION WORKS FOR IMPLEMENTATION OF THE CLIMATE PROOFED RURAL ROADS IN ARID AND SEMI-ARID LANDS (ASAL) - AREA 2.

AFD/EU/GOK ROADS 2000 CLIMATE PROOFED, AREA 2: ISIOLO, SAMBURU AND MARSABIT COUNTIES

Drawing title:
STANDARD DRAWINGS
STANDARD TRAFFIC SIGNS DETAILS

Scale: (1:2000)

Sheet:

	Drawn by	: R.T
	Designed by	: N.O
	Checked by	: C.O
	Approved by	: C.O
	Date	: AUGUST, 2023.
	Client approval	:
f 2	Drg No.	: R2000/IMO/2023/TS/01

PUBLICITY SIGNBOARD












AS CONSULTANTS LTD Le'Mac Building, 1st Floor, off Church P.O.Box 20023.00200

DESIGN AND SUPERVISION WORKS FOR IMPLEMENTATION OF THE CLIMATE PROOFED RURAL ROADS IN ARID AND SEMI-ARID LANDS (ASAL) - AREA 2.

Drawing title:			Drawn by	: R.T
PUBLICITY BILLBOAF	חס		Designed by	: N.O
POBLICITY BILLBOAR	ND.		Checked by	: C.O
			Approved by	: C.O
			Date	: AUGUST, 2023.
Scale: (1:2000)	Sheet:		Client approval	:
		1 of 2		

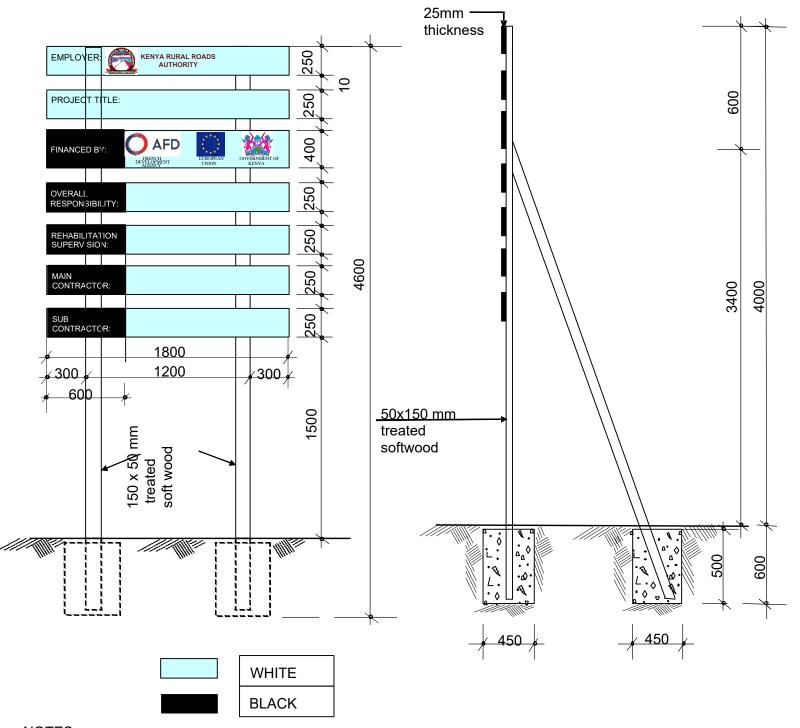

NOTES

- 1. The wording of the project signboard and the location to be installed to be as directed by the Engineer
- 2. Materials to be used for fabrication of signboard shall be pressure impregnated treated softwood timber sizes as indicated in the drawing
- 3. Wording boards to be nailed to the posts using nails.
- 4. Project board posts and struts to be embedded in concrete ratio 1:2:4

